
GENERAL CONSTRUCTION NOTES

- 1. THE CONTRACTOR SHALL NOTIFY DIG SAFELY NEW YORK NOT LESS THAN THREE DAYS PRIOR TO ANY SUBSURFACE CONSTRUCTION AT (800)962-7692.
- 2. THE CONTRACTOR SHALL BE RESPONSIBLE FOR VERIFYING ALL DIMENSIONS, GRADES, QUANTITIES, AND FIELD CONDITIONS PRIOR TO BIDDING THE WORK OR ORDERING THE MATERIALS.
- UNDERGROUND FACILITIES, STRUCTURES, AND UTILITIES HAVE BEEN MAPPED FROM DATA OBTAINED BY FIELD SURVEY, PREVIOUS MAPS, OR RECORDS, THEREFORE THEIR LOCATIONS SHALL BE CONSIDERED APPROXIMATE ONLY. THERE MAY BE OTHER UNDERGROUND UTILITIES, THE EXISTENCE OF WHICH ARE NOT KNOWN TO THE UNDERSIGNED. SIZE AND LOCATION OF ALL UNDERGROUND UTILITIES AND STRUCTURES SHALL BE VERIFIED BY THE APPROPRIATE AUTHORITIES PRIOR TO CONSTRUCTION.
- 4. ALL EXISTING TOPOGRAPHIC FEATURES WHICH INCLUDE BUT ARE NOT LIMITED TO, WALKS, WALLS, CURBS, STEPS, TREES, SHRUBS, AND UTILITIES ADJACENT TO THE WORK SHALL BE MAINTAINED IN THEIR CURRENT CONDITION, UNLESS NOTED OTHERWISE ON THE DRAWINGS. THE CONTRACTOR SHALL VERIFY THE LOCATION AND CONDITION OF THESE ITEMS IN THE FIELD PRIOR TO STARTING WORK. ANY ITEMS FOUND TO CONFLICT WITH THE WORK REQUIRED AS PART OF THIS CONTRACT SHALL BE IMMEDIATELY REPORTED IN WRITING TO THE ENGINEER. THE CONTRACTOR SHALL FIELD VERIFY EXISTING TOPOGRAPHY PRIOR TO COMMENCEMENT OF EARTHWORK OPERATIONS. ANY ELEVATION DISCREPANCIES WHICH AFFECT THE WORK REQUIRED AS PART OF THE THE CONTRACT DOCUMENTS SHALL BE IMMEDIATELY REPORTED IN WRITING TO THE ENGINEER AND DEVELOPER. COMMENCEMENT OF WORK WITHOUT THIS WRITTEN NOTIFICATION SHALL CONSTITUTE CONTRACTOR ACCEPTANCE OF THE EXISTING TOPOGRAPHY INDICATED ON THE DRAWINGS AS ACCURATE. NO ADJUSTMENT TO THE CONTRACT WILL BE MADE FOR DISCREPANCIES BROUGHT TO THE ATTENTION OF THE ENGINEER AFTER THE WORK HAS BEGUN.
- 5. THE CONTRACTOR SHALL VISIT THE SITE TO DETERMINE THE LIMITS OF DEMOLITION REQUIRED TO COMPLETE THE WORK. TOP 18" OF MATERIALS SHALL BE REMOVED FROM THE ENTIRE SITE BEFORE BEGINNING ANY CONSTRUCTION. PURPOSE IS TO REMOVE ANY FOREIGN AND ORGANIC MATTER BEFORE CONSTRUCTION. ANY FILL MATERIAL. REQUIRED FOR CONSTRUCTION SHALL BE APPROVED CRUSHER RUN.
- 6. THE CONTRACTOR SHALL CONFORM TO THE NEW YORK STATE DEPARTMENT OF ENVIRONMENTAL CONSERVATION GUIDELINES FOR URBAN EROSION AND SEDIMENTATION CONTROL.
- THE NEW ASPHALT DRIVEWAY SHALL BE CONSTRUCTED WITH A FULL-DEPTH PAVEMENT SECTION AS DETAILED ON SHEET D-1. ALL ASPHALT SHALL BE INSTALLED IN ACCORDANCE WITH NYSDOT STANDARD SPECIFICATIONS SECTION 403. EXCAVATION AND REMOVAL OF EXISTING SPOIL AND UNSUITABLE MATERIAL SHALL COMPLY WITH NYSDOT STANDARD SPECIFICATIONS SECTION 200 AND SHALL BE PROPERLY DISPOSED OF OFF SITE. ALL NEW TACK COAT SHALL COMPLY WITH NYSDOT ITEM #407.0101 AND NYSDOT STANDARD SPECIFICATIONS SECTION
- 8. ALL PAVEMENT MARKINGS SHALL BE PAINTED WITH NYSDOT APPROVED PAVEMENT MARKING REFLECTORIZED EPOXY PAINT AND SHALL BE APPLIED AS RECOMMENDED BY THE MANUFACTURER AND SHALL COMPLY WITH NYSDOT STANDARD SPECIFICATIONS SECTION 685.
- 9. ALL ADA PARKING SPACES AND ACCESS AISLES SHALL HAVE SIGNS AND PAVEMENT MARKINGS PLACED IN ACCORDANCE WITH NYSDOT STANDARD DETAIL SHEET M608-4R1. THE INTERNATIONAL ACCESS SYMBOL SHALL BE STENCILED IN EACH ADA DESIGNATED PARKING SPACE.
- 10. ALL DISTURBED AREAS ADJACENT TO EXISTING LAWN AREAS SHALL RECEIVE 4" OF TOPSOIL, SEED AND MULCH AS REQUIRED TO RESTORE THE PROJECT SITE. ALL TOPSOIL SHALL COMPLY WITH NYSDOT STANDARD SPECIFICATIONS SECTION 613 AND ALL SEEDING AND MULCH SHALL COMPLY WITH NYSDOT STANDARD SPECIFICATIONS SECTION 610.
- 11. ALL UTILITY CONNECTIONS INCLUDING NEW WATER SERVICE, SANITARY SEWER, ELECTRICAL, ETC. SHALL BE COORDINATED WITH UTILITY OWNER(S) AND INSTALLED IN ACCORDANCE WITH THEIR STANDARDS AND/OR UNDER THEIR DIRECT SUPERVISION
- 12. NEW CONCRETE SHALL HAVE A MINIMUM 28 DAY COMPRESSIVE STRENGTH OF 4,000 PSI. ALL PORTLAND CEMENT SHALL COMPLY WITH ASTM C150, TYPE IIA AND SHALL HAVE 6.5% ENTRAINED AIR AND THE WATER-CEMENT RATIO SHALL NOT EXCEED 0.40. ALL NEW CONCRETE CURBS AND SIDEWALKS SHALL COMPLY WITH NYSDOT CLASS A CONCRETE AND SHALL HAVE A LIGHT BROOM FINISH. ALL CONCRETE SHALL BE SEALED WITH CURING COMPOUND AFTER FINISHING.
- 13. PAVEMENT SPOT ELEVATION SHOWN TO FINISHED GRADE OF PAVEMENT. TOP OF CURB TO BE 6" ABOVE FINISHED GRADE OF PAVEMENT.
- 14. IF CURB/SIDEWALK SECTIONS ARE TO BE REMOVED; THEY SHALL BE SAWCUT AND REMOVED TO THE EXTENT NEEDED FOR INSTALLATION OF PROPOSED UTILITY. REMOVED SECTIONS SHALL BE REPLACED IN KIND TO THE SATISFACTION AND SPECIFICATIONS OF THE OWNER OR ENGINEER.

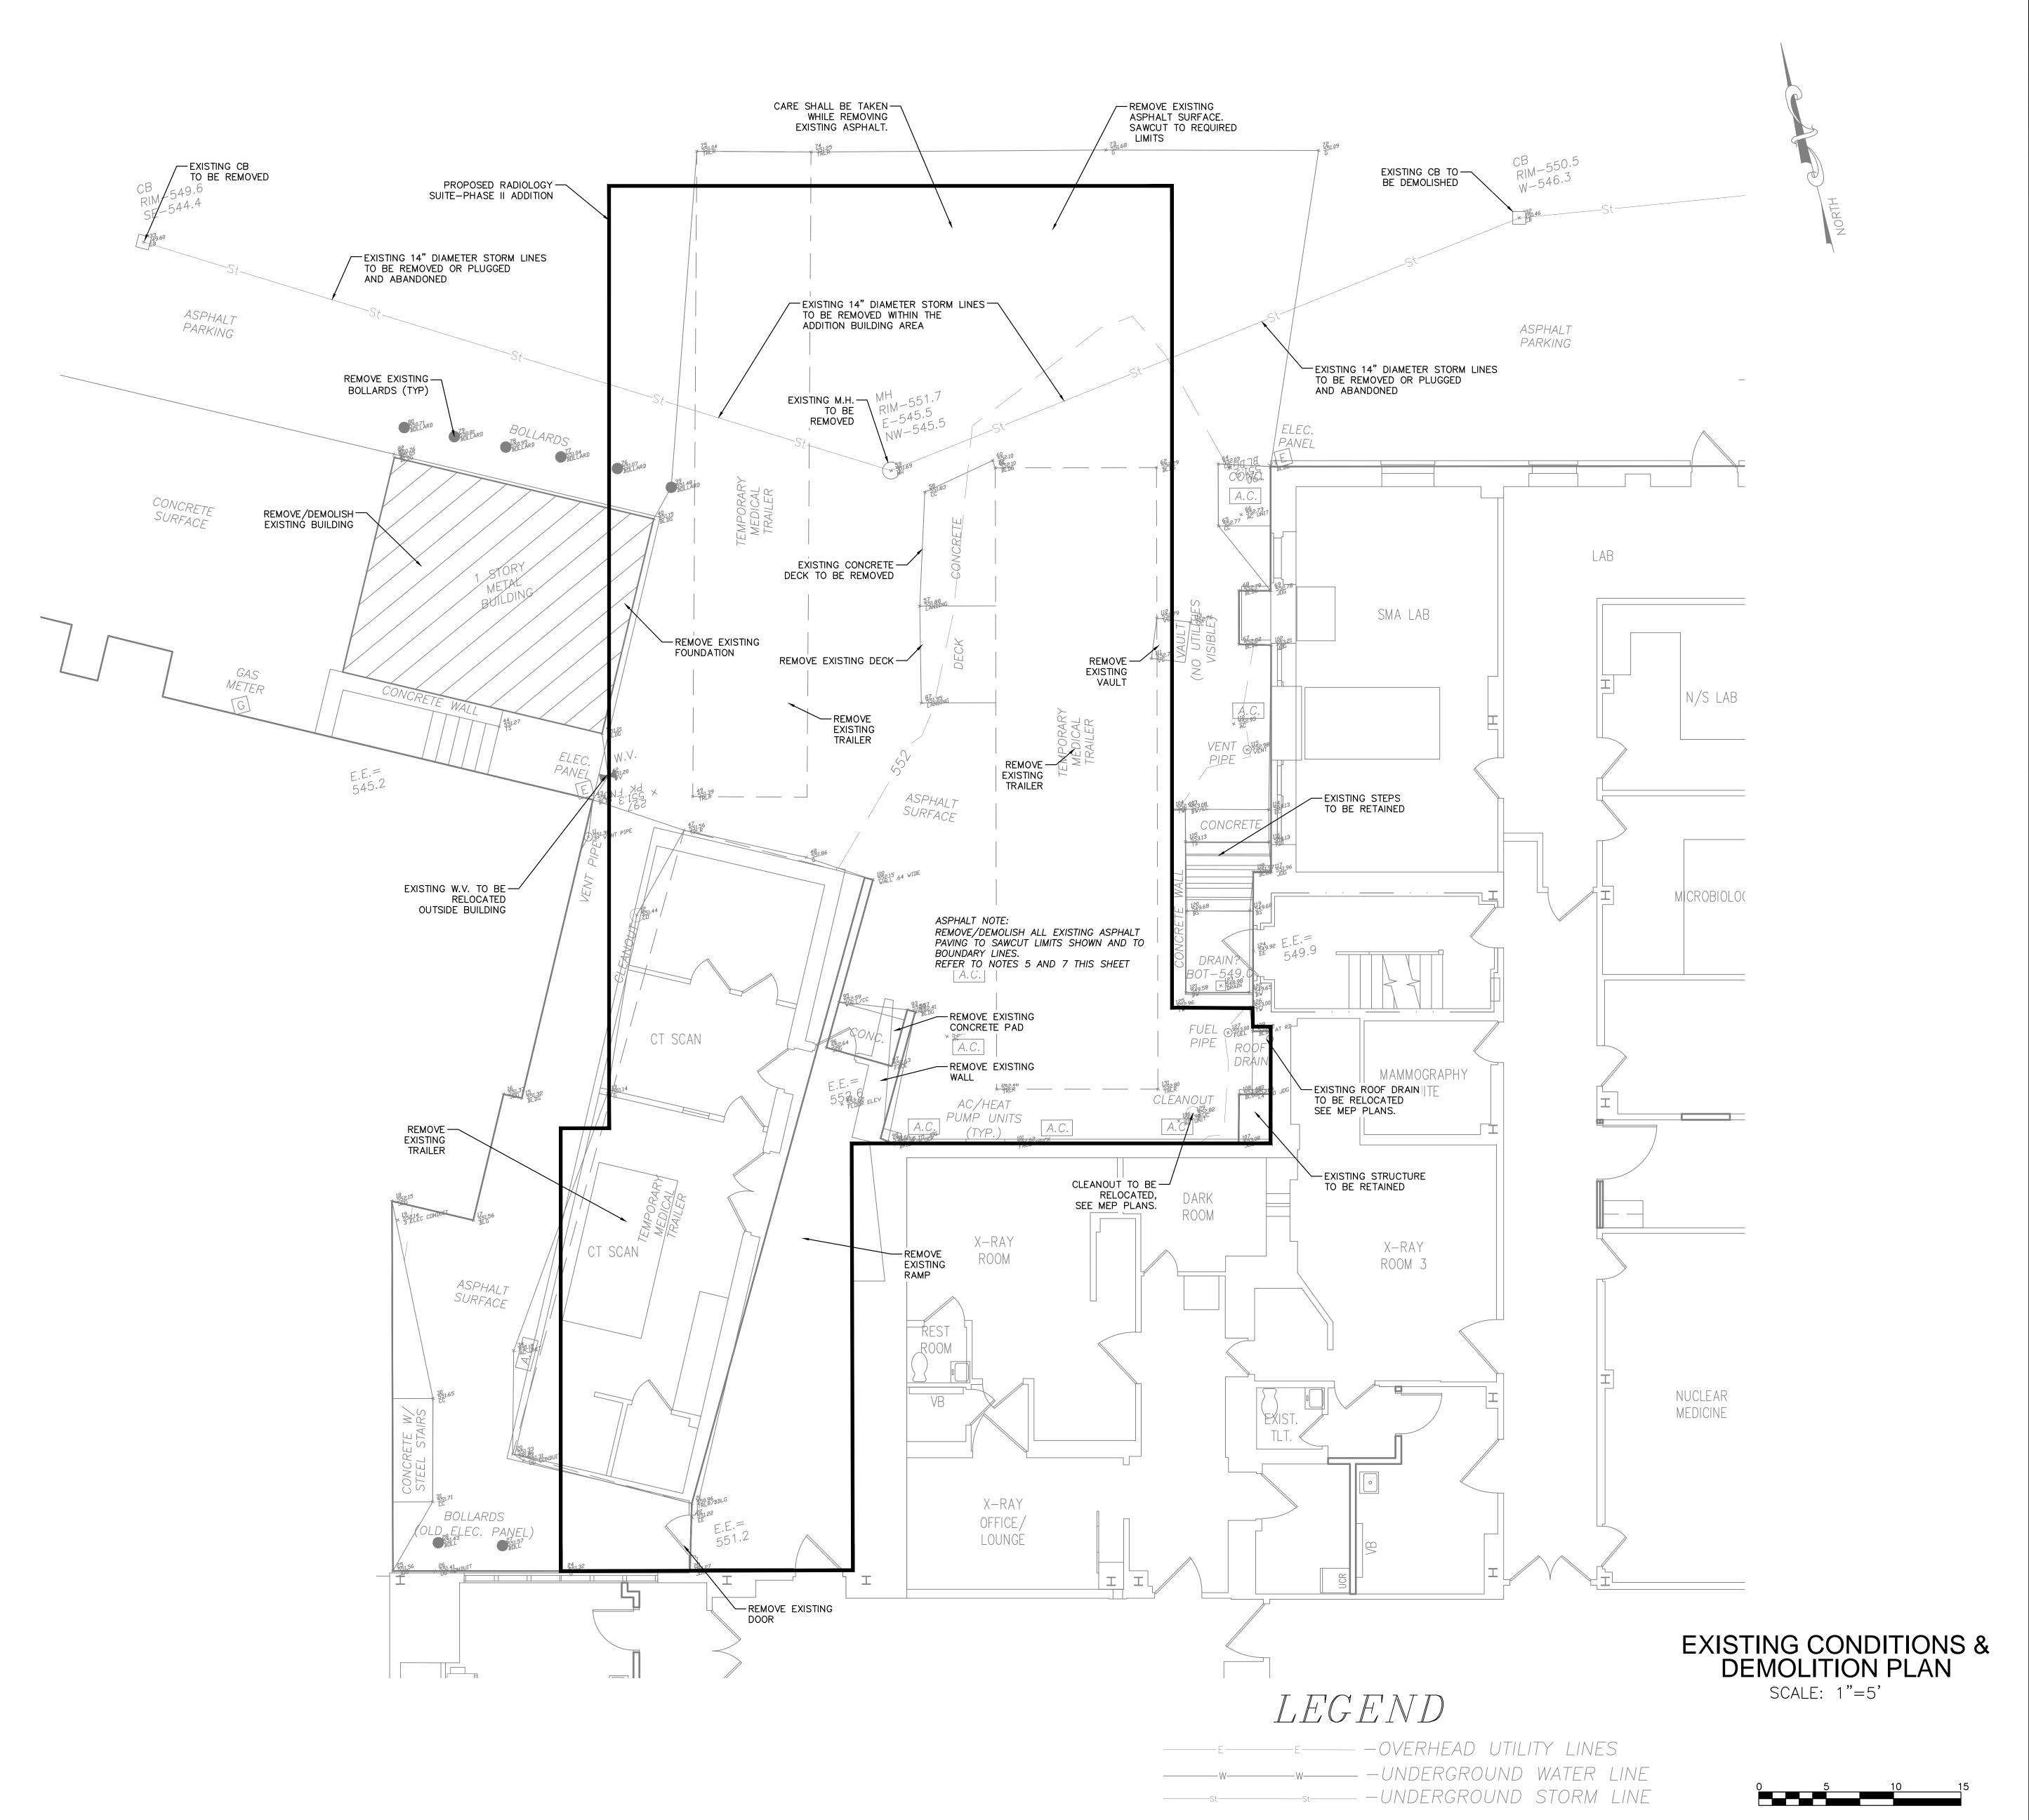

A S S O C I A T E S

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PROJECT TITLE:

WMC V

VIOLATION OF THE LAW AND IS PROHIBITED.

BON SECOURS CHARITY HEALTH SYSTEM A member of the Westchester Medical Center Health Network St. Anthony Community

Hospital 15 Maple Ave, Warwick, NY 10990

Radiology Suite Phase II

RADIOLOGY ADDITION **EXISTING CONDITIONS & DEMOLITION PLAN**

PROJECT NO:

C-1


CAD FILE: STANTHONY HOSPITAL-RADIOLEOCYCNUTED ATASE II 24000 FEOLONIC

UTILITY NOTES: 1. THE CONTRACTOR IS RESPONSIBLE TO CONTACT NY811 (DIG SAFELY NEW YORK 1-800-962-7692) AT LEAST 3 WORKING DAYS PRIOR TO THE START OF CONSTRUCTION OR DEMOLITION WORK FOR THE IDENTIFICATION OF UTILITIES IN THE VICINITY OF THE WORK AREA. 2. THE EXISTING UTILITIES SHOWN ON PLANS ARE FOR REFERENCE ONLY AND ARE NOT TO BE CONSTRUED AS AN ACCURATE OR ALL-INCLUSIVE REPRESENTATION OF THE UTILITIES PRESENT WITHIN THE WORK AREA. THE CONTRACTOR IS RESPONSIBLE FOR CONFIRMING THE LOCATIONS OF ALL UTILITIES WITHIN THE WORK AREA PRIOR TO THE START OF WORK. 3. THE PROPOSED UTILITIES SHOWN ON THIS PLAN IS FOR PURPOSES ONLY. THE CONTRACTOR IS RESPONSIBLE TO COORDINATE WITH THE ENGINEER/UTILITY TO DETERMINE SIZES AND LOCATION PRIOR TO 4. ALL UTILITIES DAMAGED OR DESTROYED SHALL BE BROUGHT TO THE ATTENTION OF THE SPECIFIC UTILITY OWNER. ALL COST INCURRED TO REPAIR OR REPLACE THE UTILITY SHALL BE BORNE BY THE 5. ALL WORK ASSOCIATED WITH NEW WATER SERVICE OUTSIDE OF THE NYSDOT RIGHT-OF-WAY SHALL BE TEH RESPONSIBILITY OF THE CONTRACTOR. PROPOSED WATER SERVICE NOTES: 1. CONTRACTOR SHALL COORDINATE ALL WATER SERVICE ACTIVITY WITH THE TOWN OF WARWICK. 2. NEW WATER SERVICE SHALL BE 1 1/4" COPPER TUBING TYPE K, ASTM B88 OR SDR9 POLYETHYLENE PIPE. A COMPRESSION OR SILVER SOLDERED JOINT IS ALLOWABLE ONLY IF MORE THAN ONE COIL IS NECESSARY. NEW WATER SERVICE SHALL BE INSTALLED MIN. OF 5FT 3. CONNECTION, CURB BOX, AND STOP VALVES TO BE PROVIDED BY TOWN OF WARWICK WATER DEPARTMENT. 4. NEW WATER SERVICE TAP SHALL BE PERFORMED BY THE TOWN OF WARWICK WATER DEPARTMENT. ALL WORK WITHIN THE NYSDOT RIGHT-OF-WAY ASSOCIATED WITH THE TAP AND CONNECTION TO BE COMPLETED BY THE WATER DEPARTMENT. ALL SAWCUTTING, EXCAVATION, BACKFILL AND RESTORATION SHALL BE PERFORMED BY THE CONTRACTOR. BOLLARDS 5. ALL WORK ASSOCIATED WITH NEW WATER SERVICE OUTSIDE OF THE NYSDOT RIGHT-OF-WAY SHALL BE TEH RESPONSIBILITY OF THE CONTRACTOR. PROPOSED SEWER SERVICE NOTES: 1. TWO CLEANOUTS REQUIRED AS SHOWN ON PLANS THIS SHEET. CLECK VALVE ASSEMBLY AS PER TOWN OF WARWICK SPECEANOUT NEAR MANHOLE STRUCTURE SHALL HAVE A BACKWATER CHIFICATIONS. 2. TOWN OF WARWICK SHALL INSPECT ALL WORK COMPLETED BEFORE TICKET IS SIGNED OFF. 3. PERMIT FOR WORK SHALL BE ACQUIRED FROM THE TOWN OF WARWICK ENGINEERING DEPARTMENT. 4. CONTRACTOR SHALL COORDINATE ALL WORK WITH THE TOWN OF WARWICK SEWER DEPARTMENT. GAS METER PROPOSED RADIOLOGY SUITE PHASE-II E.E.= 545.2 EXISTING W.V.— TO BE RELOCATED OUTSIDE BUILDING SURFACE CT SCAN

ASPHALT SURFACE

BOLLARDS (OLD ELEC. PANEL)

SEE MEP PLANS FOR — ELECTRICAL SERVICE AND

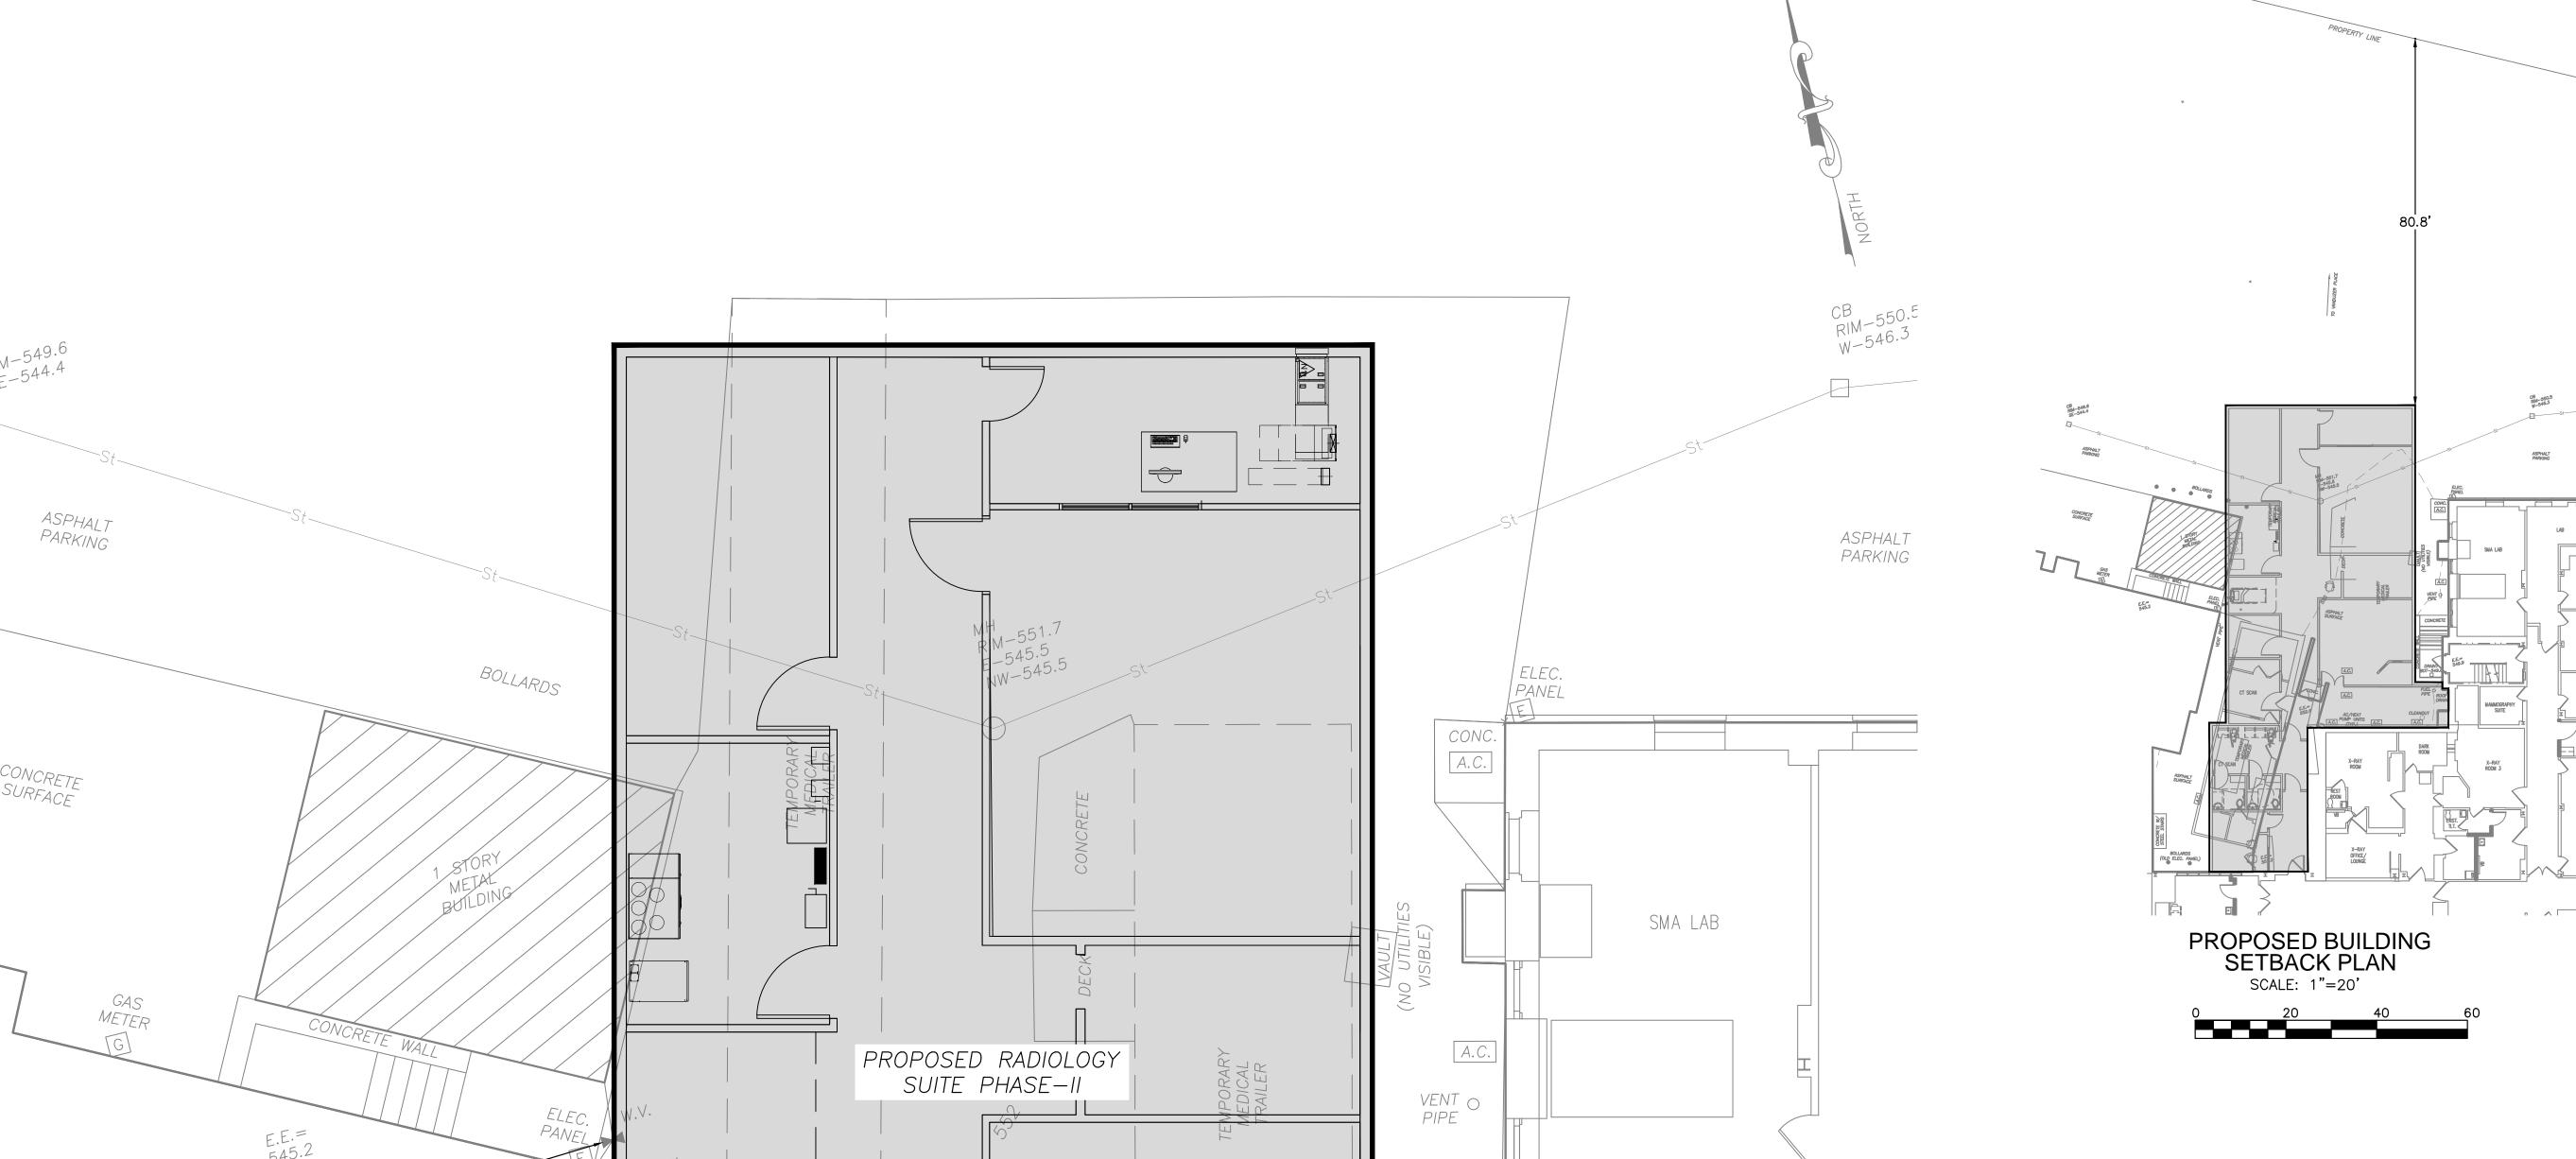

CONCRETE

CLEANOUT

DARK

ROOM

A.C.

AC/HEAT

X-RAY

ROOM

CONNECT WATER TO

EXISTING WATER MAIN.

SEE MEP PLANS

LINES TO EXISTING. SEE MEP PLANS

X-RAY

OFFICE/ LOUNGÉ MAMMOGRAPHY SUITE

X-RAY

ROOM 3

LEGEND



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Binghamton, New York 13903
Telephone (607) 724-2400 Fax (607) 724-2436

PROJECT TITLE: WMC Health

VIOLATION OF THE LAW AND IS PROHIBITED.

BON SECOURS CHARITY HEALTH SYSTEM A member of the Westchester Medical Center Health Network St. Anthony Community Hospital

15 Maple Ave, Warwick, NY 10990

Radiology Suite Phase II

RADIOLOGY ADDITION PROPOSED SITE LAYOUT AND UTILITIES


PROPOSED SITE LAYOUT AND UTILITIES

SCALE: 1"=5'

PROJECT NO:

C-2

CAD FILE: STANTHONY HOSPITAL-RADIOLIP (LYCTUTED ATASE II 28100 F 7020).DV

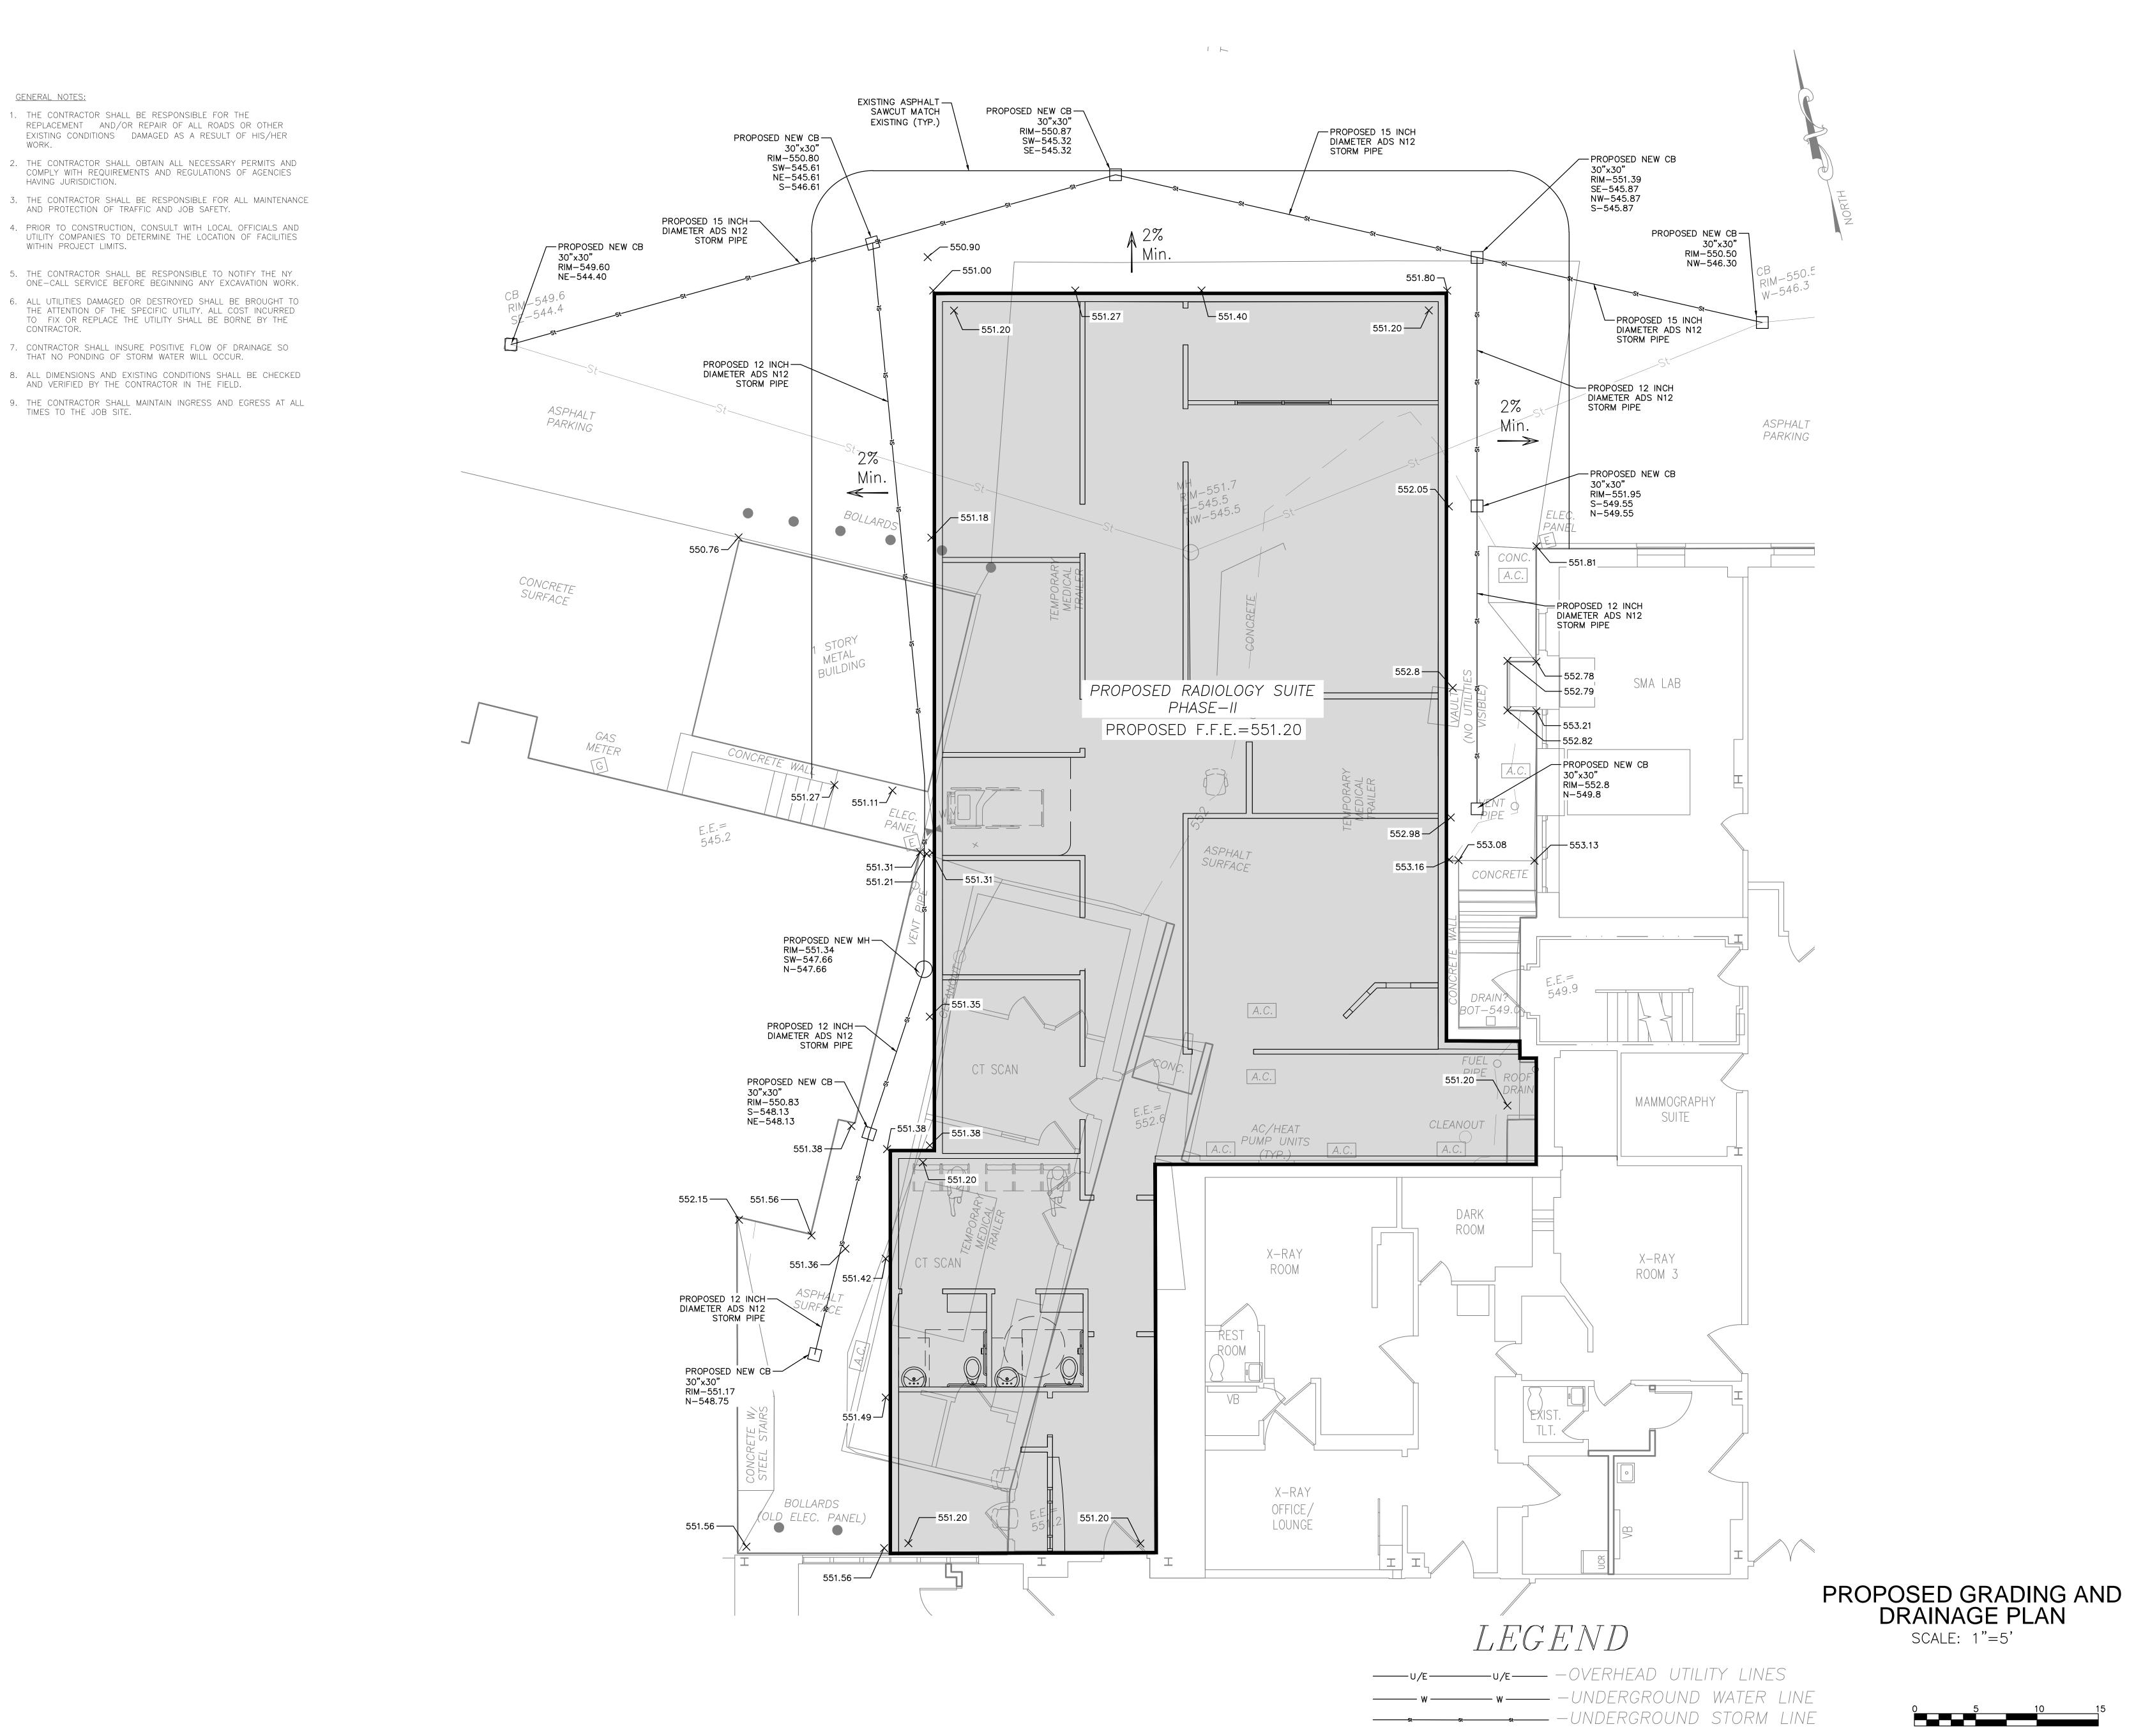

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GRIFFITHS ENGINEERING

13 South Washington Street, Suite 1

Binghamton, New York 13903

Telephone (607) 724-2400

Fax (607) 724-2436

PROJECT TITLE:



St. Anthony Community

Hospital

Son SECOURS CHARITY HEALTH SYSTEM
A member of the
Westchester Medical Center Health Network

St. Anthony Community

Hospital

Son SECOURS CHARITY HEALTH SYSTEM
A member of the
Westchester Medical Center Health Network

St. Anthony Community

Hospital

Son SECOURS CHARITY HEALTH SYSTEM
A member of the
Westchester Medical Center Health Network

St. Anthony Community

Hospital

Son Secours Charity Health System
A member of the
Westchester Medical Center Health Network

St. Anthony Community

Radiology Suite Phase II

RADIOLOGY ADDITION
PROPOSED GRADING AND
DRAINAGE PLAN

DRAWN BY: CHECKED BY:

A.K.V.

D.G.

PROJECT NO:

-

C-3

CAD FILE: STANTHONY HOSPITAL-RADIOLIPIE/STUTTED ATTASE II 24/00/12/02/N.D.

PLAN PREPARER AND CONTACT INFORMATION DANIEL GRIFFITHS, P.E. GRIFFITHS ENGINEERING, LLC 13 SOUTH WASHINGTON STREET, BINGHAMTON NY 13903 PHONE: (607)724-2400 / FAX: (607)724-2436

<u>GENERAL NOTES:</u>
CONTRACTOR SHALL ABIDE BY ALL RULES AND REGULATIONS PUBLISHED BY THE NEW YORK STATE DEPARTMENT OF ENVIRONMENTAL CONSERVATION UNDER THE "NEW YORK STATE STANDARDS AND SPECIFICATIONS FOR SOIL EROSION AND SEDIMENT CONTROL".

SEE EROSION CONTROL DETAILS ON SHEET D-1

E&S POLLUTION CONTROL PLAN NOTES:1. THERE ARE NO NATURALLY OCCURRING GEOLOGIC FORMATIONS OR SOIL CONDITIONS HAVING THE POTENTIAL TO CAUSE POLLUTION. 2. POTENTIAL THERMAL IMPACTS RESULTING FROM THIS PROJECT

HAVE BEEN MITIGATED BY: 2.1. MINIMIZING DISTURBED AREA ON THE SITE.

GENERAL NOTES:

1. REFER TO SHEET D-1 FOR NOTES AND DETAILS PERTINENT TO

- EROSION AND SEDIMENT POLLUTION CONTROL. 2. STEEP SLOPES SHALL BE STABILIZED WITH EROSION CONTROL BLANKETS (NORTH AMERICAN GREEN DS75, STAPLE PATTERN B OR APPROVED EQUAL), OR SPRAYED BONDED FIBER MATRIX APPLIED AT A RATE OF 3,000 - 4,000 lbs/ac. REFER TO NOTES AND DETAILS ON SHEET D-1.
- 3. THERE ARE NO RIPARIAN AREAS WITHIN THE MAPPING LIMITS OF THESE PLANS.
- 4. THE PROJECT IS ANTICIPATED TO BEGIN ONCE PERMITTING APPROVED WITH FINAL STABILIZATION TO FOLLOW.

CONTRACTOR NOTES:
THE CONTRACTOR IS RESPONSIBLE TO MAINTAIN ALL EROSION AND SEDIMENTATION CONTROL MEASURES DURING CONSTRUCTION. IF UNFORESEEN CIRCUMSTANCES ARE DISCOVERED— I.E. SOIL EROSION, DISPLACED STONE, UNINTENDED LOSS OF VEGETATION; APPROPRIATE MEASURES SHALL BE TAKEN TO REMEDY THE SITUATION UNDER THE DIRECTION OF THE ENGINEER AND/OR THE OSWEGO COUNTY CONSERVATION DISTRICT.



1 -

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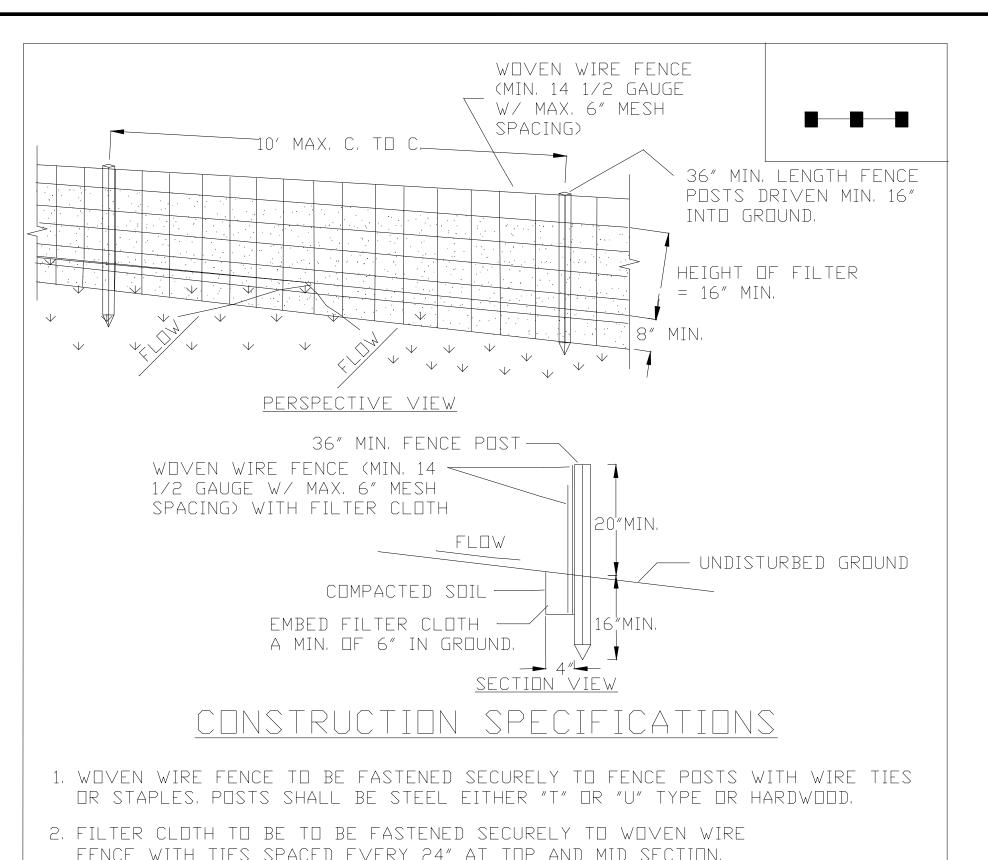
Radiology Suite Phase II

RADIOLOGY ADDITION **EROSION AND SEDIMENTION** CONTROL PLAN

PROJECT NO:

C-4


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- FENCE WITH TIES SPACED EVERY 24" AT TOP AND MID SECTION. FENCE SHALL BE WOVEN WIRE, 12 1/2 GAUGE, 6" MAXIMUM MESH OPENING.
- 3. WHEN TWO SECTIONS OF FILTER CLOTH ADJOIN EACH OTHER THEY SHALL BE OVER-LAPPED BY SIX INCHES AND FOLDED. FILTER CLOTH SHALL BE EITHER FILTER X, MIRAFI 100X, STABILINKA T140N, OR APPROVED EQUIVALENT.
- 4. PREFABRICATED UNITS SHALL BE GEOFAB, ENVIROFENCE, OR APPROVED EQUIVALENT.
- 5. MAINTENANCE SHALL BE PERFORMED AS NEEDED AND MATERIAL REMOVED WHEN "BULGES" DEVELOP IN THE SILT FENCE.

U.S. DEPARTMENT OF AGRICULTURE NATURAL RESOURCES CONSERVATION SERVICE NEW YORK STATE DEPARTMENT OF ENVIRONMENTAL CONSERVATION NEW YORK STATE SOIL & WATER CONSERVATION COMMITTEE

SILT FENCE



CONSTRUCTION SPECIFICATIONS

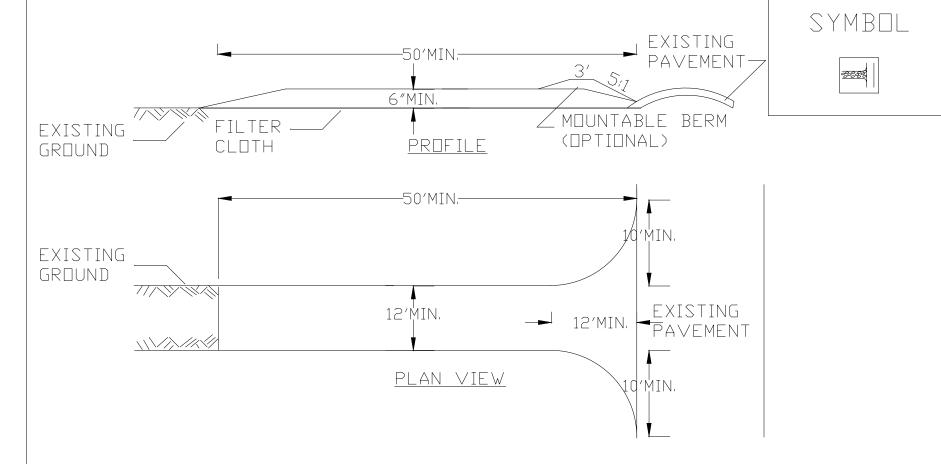- 1. STONE SIZE USE 2" STONE, OR RECLAIMED OR RECYCLED CONCRETE EQUIVALENT. 2. LENGTH - NOT LESS THAN 50 FEET (EXCEPT ON A SINGLE RESIDENCE LOT WHERE A 30 FOOT MINIMUM LENGTH WOULD APPLY).
- 3. THICKNESS NOT LESS THAN SIX (6) INCHES.
- 4. WIDTH TWELVE (12) FOOT MINIMUM, BUT NOT LESS THAN THE FULL WIDTH AT POINTS WHERE INGRESS OR EGRESS OCCURS, TWENTY-FOUR (24) FOOT IF SINGLE ENTRANCE TO SITE.
- 5. FILTER CLOTH WILL BE PLACED OVER THE ENTIRE AREA PRIOR TO PLACING OF STONE.
- 6. SURFACE WATER ALL SURFACE WATER FLOWING OR DIVERTED TOWARD CON-STRUCTION ENTRANCES SHALL BE PIPED ACROSS THE ENTRANCE, IF PIPING IS IMPRACTICAL, A MOUNTABLE BERM WITH 5:1 SLOPES WILL BE PERMITTED.
- '. MAINTENANCE THE ENTRANCE SHALL BE MAINTAINED IN A CONDITION WHICH WILL PREVENT TRACKING OR FLOWING OF SEDIMENT ONTO PUBLIC RIGHTS-OF-WAY, ALL SEDIMENT SPILLED, DROPPED, WASHED OR TRACTED ONTO PUBLIC RIGHTS-OF-WAY MUST BE REMOVED IMMEDIATELY.
- 8. WHEN WASHING IS REQUIRED, IT SHALL BE DONE ON A AREA STABILIZED WITH STONE AND WHICH DRAINS INTO AN APPROVED SEDIMENT TRAPPING DEVICE.

STABILIZED

CONSTRUCTION

ENTRANCE

-EXISTING ASPHALT PAVEMENT

NYSDOT TYPE 2 SUBBASE ITEM

-PLACE COLOR CODED

MINIMUM 12" ABOVE

OF 30" BELOW GRADE.

NO. 2 CRUSHED STONE

TOP OF PIPE MAXIMUM

TRENCH BACKFILL: NYSDOT

TYPE 2 SUBBASE ITEM 304.12

UTILITY TAPE AT

-SAWCUT PAVEMENT

304.12

NYSDOT

- CUSHION SAND

(2) 4" DIA. —SCHEDULE 80

PVC ELECTRICAL CONDUITS

9. PERIODIC INSPECTION AND NEEDED MAINTENANCE SHALL BE PROVIDED AFTER EACH RAIN.

			U,S	. DEPAR	RTME	NT DF	AGRIO	CULTU	RE		
		NAT	URAL	RESOU	RCE:	S CONS	SERVA	TION S	SERV	/ICE	
NEV	W Y 🗆	RK ST	ATE I	DEPARTI	MENT	of E	INVIRO	NMENT	AL (CONSER	RVATI
	NEW	YORK	STAT	E SOIL	& '	WATER	CONS	ERVAT	\square	$C\square MMI$	TTEE

AND MULCH

SHEETING AND BRACING -

PROTECT OTHER WORKS

WHERE REQUIRED TO

OR FOR SAFETY.

TRENCH BACKFILL:


SUBSOIL TYPE S1 🔻


EXISTING GRASS 7 4

TOPSOIL, SEED GRASS ASPHALT PAVT.

+-+

SECTION SECTION

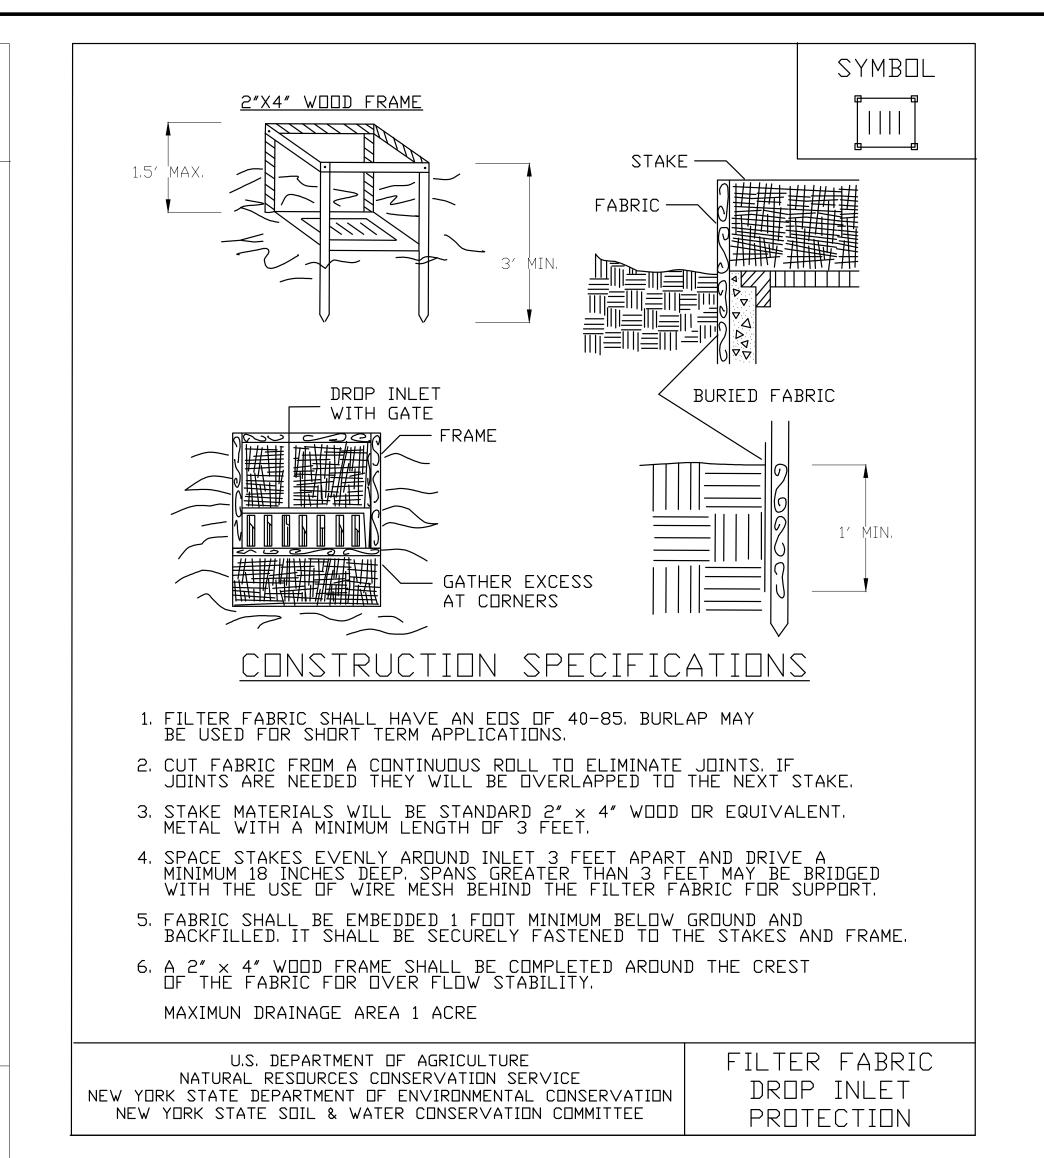


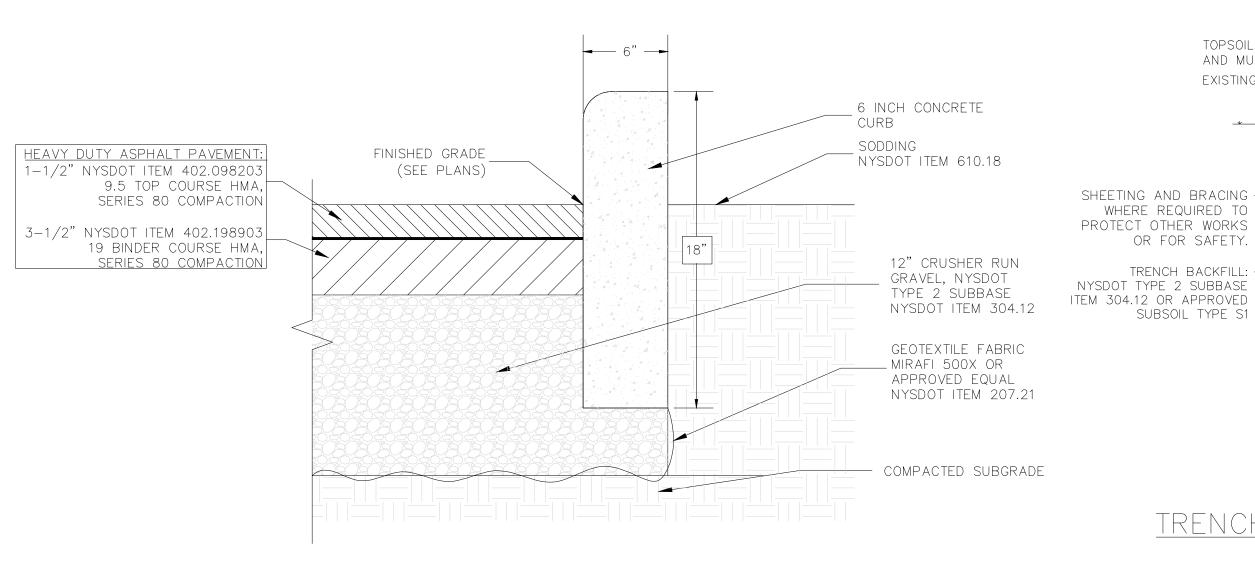

NOTES:

- 1. EXCAVATE AND DISPOSE OF ALL EXISTING MATERIAL REQUIRED TO INSTALL CROSS SECTION OF
- 2. INSTALL GEO TEXTILE FABRIC BETWEEN COMPACTED SUBGRADE AND TYPE 2 SUBBASE.
- 3. INSTALL SUBBASE MATERIAL FINE GRADE & ROLL SUBBASE COMPACT TO 95% PROCTOR COMPACTED LIFTS NOT TO EXCEED 6 INCHES.
- 4. APPLY TACK COAT TO ALL VERTICAL SURFACES ADJACENT TO NEW ASPHALT PAVEMENT.
- 5. PLACE ASPHALT COURSES COMPACTED TO MEET NYSDOT STANDARDS AND SPECIFICATIONS SECTION 402 DATED MAY 1 2019.


ASPHALT PAVEMENT SECTION NOT TO SCALE

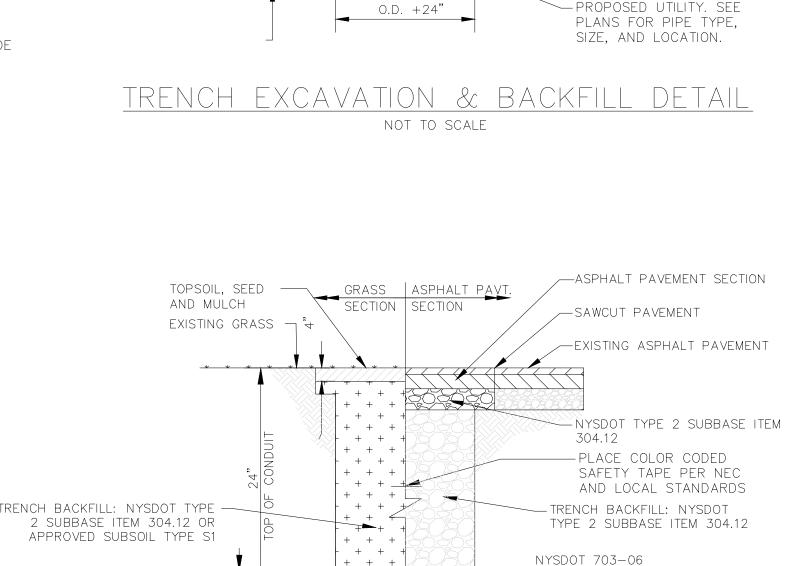

ELECTRICAL SERVICE TRENCH EXCAVATION & BACKFILL

O.D. +24"

NOT TO SCALE

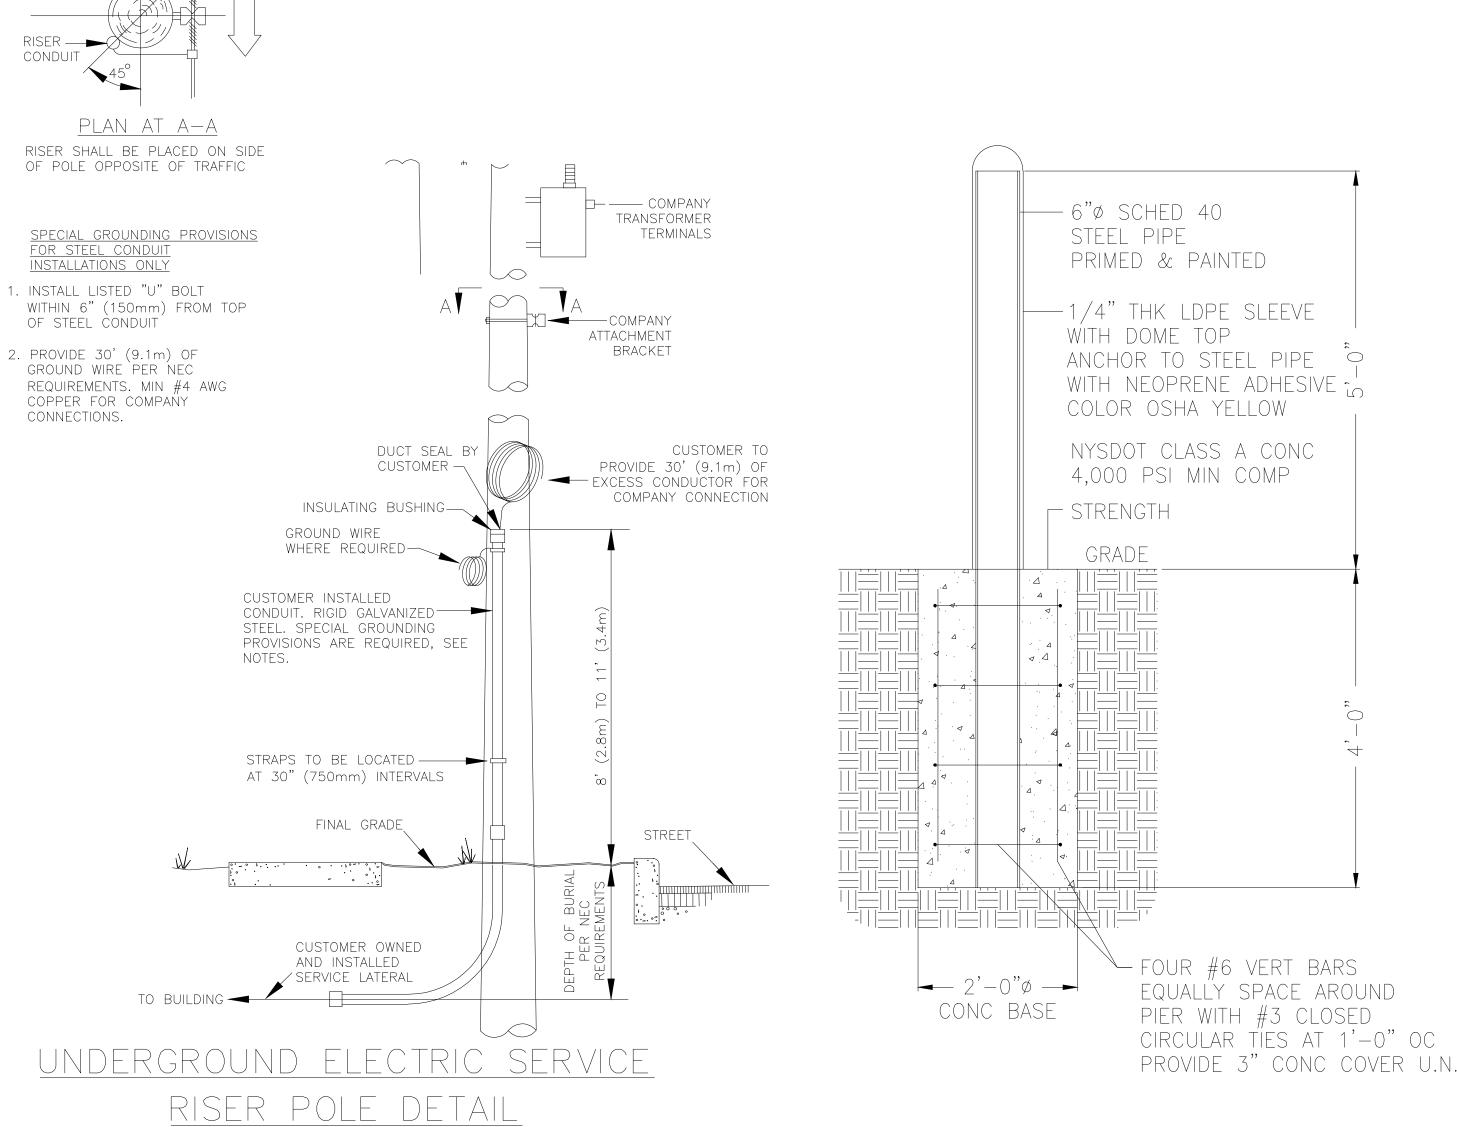

NOT TO SCALE

VIOLATION OF THE LAW AND IS PROHIBITED. PROVIDE 3" CONC COVER U.N.O.





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REVISION NO:

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Highland Center

Interior Design

Clarks Summit, PA 18411

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PROJECT TITLE:


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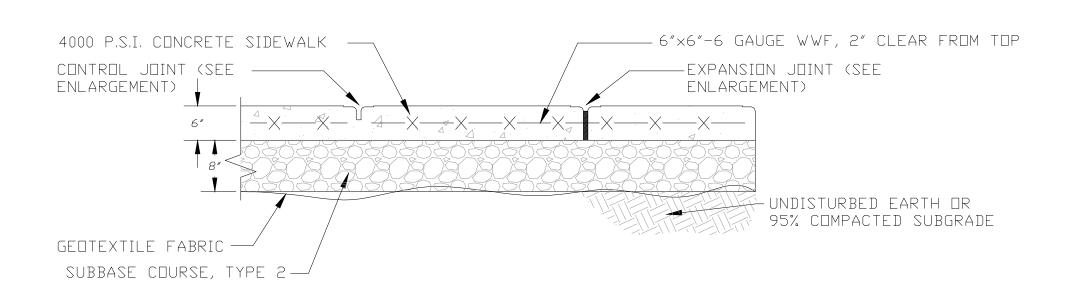
Radiology Suite Phase II

RADIOLOGY ADDITION NOTES AND DETAILS

CHECKED BY: D.G. PROJECT NO: DRAWING NO:


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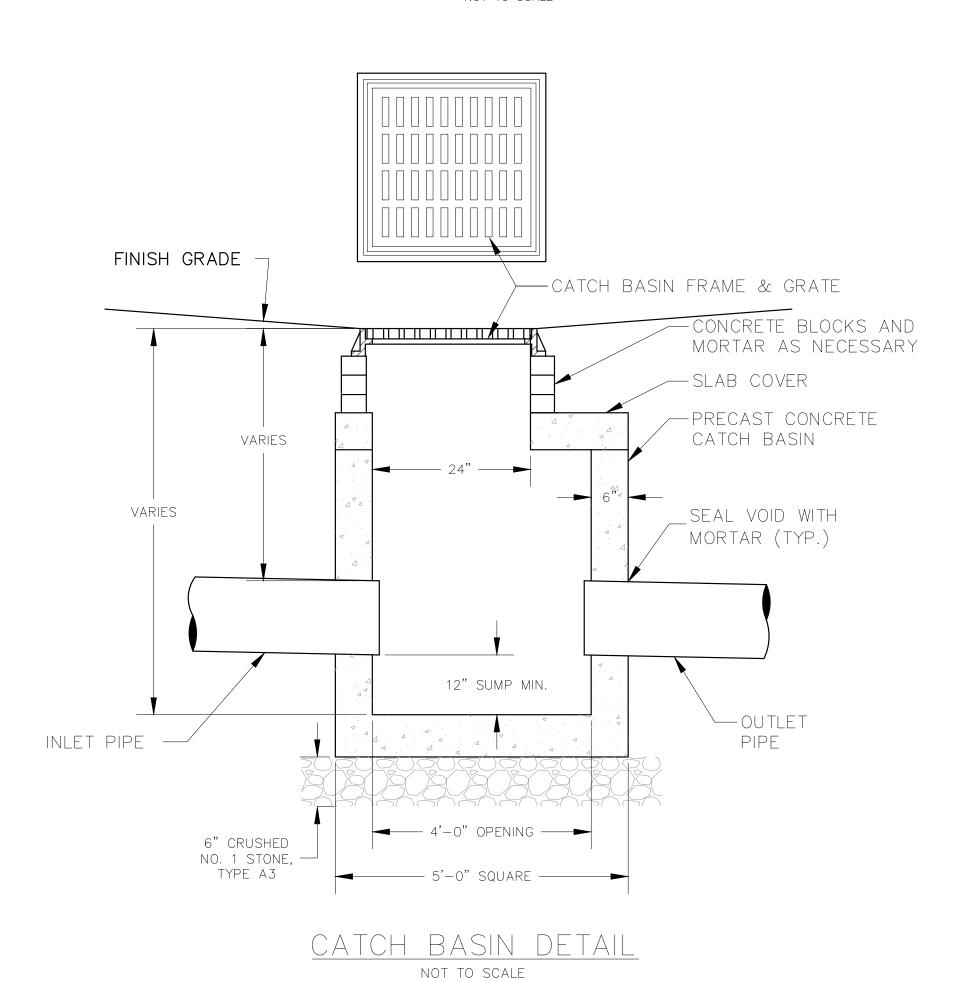
TO DIRECTION OF FOOT TRAVEL


CONCRETE SIDEWALK DETAIL (NO CURB)
NOT TO SCALE

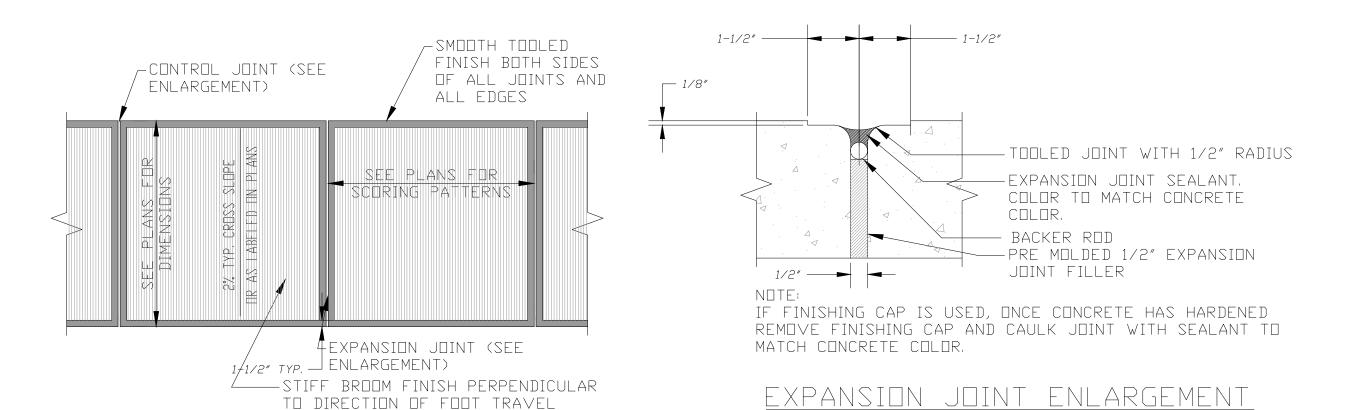

ALL CONCRETE PAVEMENT CRACK CONTROL JOINTS SHALL BE ESTABLISHED BY USE OF 1 1/2" DEEP SPEED-E-JOINT PREFORMED CONTRACTION JOINT EMBEDDED STRIPS BY W.R. MEADOWS, INC. OR APPROVED EQUAL. SPACING AND LOCATION OF CRACK CONTROL JOINTS SHALL BE AS SHOWN ON SITE PLAN.

CONCRETE DUMPSTER PAD/ TRANSFORMER PAD SECTION DETAIL NOT TO SCALE

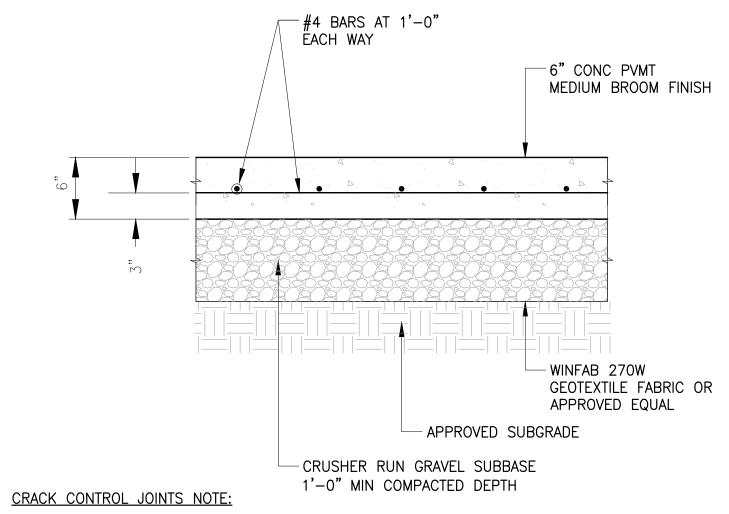

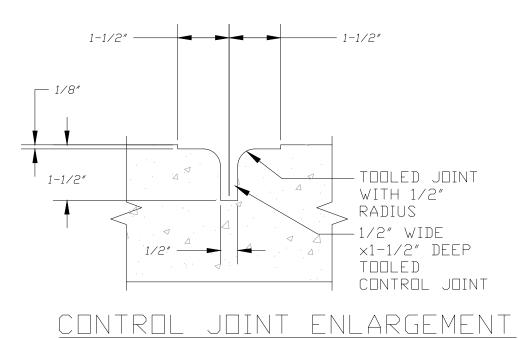

- 1. LOCATE EXPANSION JOINTS AS SHOWN ON PLANS OR AT MAXIMUM 30'-0" IN ANY DIRECTION,
- 2. PROVIDE EXPANSION JOINTS AT CONTACT POINTS WITH BUILDINGS, NEW OR EXISTING CONCRETE, AND ANY PERMANENT STRUCTURES.
- 3. LOCATE CONTROL JOINTS AS SHOWN ON PLANS OR IF NOT SHOWN ON PLANS AT 5'-0" ON CENTER.
- 4. EDGES OF CONCRETE SHALL BE TOOLED WITH 1/2" RADIUS. 5. AFTER CONCRETE HAS CURED, SEAL EXPOSED CONCRETE. REFER TO SITE CONCRETE SPECIFICATION FOR SEALING COMPOUND REQUIREMENTS, APPLY PER MANUFACTURERS RECOMMENDATION

A S S O C I A T E S

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15 Maple Ave, Warwick, NY 10990

Radiology Suite Phase II

DRAWING TITLE: RADIOLOGY ADDITION NOTES AND DETAILS

CHECKED BY: PROJECT NO: DRAWING NO:

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