

LOCATION MAP
SCALE: 1"=2000'

BULK REQUIREMENTS
LI (LIGHT INDUSTRIAL) ZONE
USE GROUP "N/A"

	MINIMUM REQUIRED	PROPOSED
MINIMUM LOT AREA (SQ. FT.)	N/A	1,271,952
LOT WIDTH (FT.)	N/A	740
FRONT SETBACK (FT.)	N/A	975.3
FRONT YARD (FT.)	N/A	335
SIDE SETBACK (FT.)	N/A	119.6
TOTAL SIDE SETBACK (FT.)	N/A	659.1
SIDE YARD (FT.)	N/A	119.8
SIDE YARD 25' OF A RESIDENTIAL DISTRICT BOUNDARY (FT.)	N/A	119.77
REAR SETBACK (FT.)	N/A	683.3
REAR YARD (FT.)	N/A	683.9
REAR YARD 25' OF A RESIDENTIAL DISTRICT BOUNDARY (FT.)	N/A	683.3
STREET FRONTAGE (FT.)	N/A	162
FLOOR AREA RATIO	N/A	N/A
	MAXIMUM ALLOWED	PROPOSED
BUILDING HEIGHT (FT.)	N/A	35
BUILDING COVERAGE (%)	N/A	0.01%

SHEET INDEX

1. SITE PLAN
2. ELECTRICAL SERVICE TRANSMISSION PLAN & ENLARGED SITE & SEDIMENT & EROSION CONTROL PLAN PROPOSED LIGHTING PLAN
3. SITE DETAILS

RECORD OWNER

WARWICK VALLEY BBA LLC
P.O. BOX 469
WARWICK NY 10990

APPLICANT

CONVERGENT ENERGY + POWER
7 TIMES SQUARE TOWER, SUITE 3504
NEW YORK, N.Y. 10036

5	REVISED PER PLANNING BOARD COMMENTS DATED 12-08-20	12-09-20
4	REVISED PER PLANNING BOARD COMMENTS DATED 11-03-20	11-11-20
3	O&R SOURCE DATA ADDED TO PLANS	09-10-20
2	REVISED PER PLANNING BOARD COMMENTS DATED 08-04-20	08-06-20
1	REVISED PER PLANNING BOARD COMMENTS DATED 07-06-20	07-16-20
NO.	DESCRIPTION	DATE

SITE PLAN

PROPOSED BATTERY ENERGY STORAGE SYSTEM AREA
PREPARED FOR




SECTION 208 BLOCK 2 LOT 10
VILLAGE OF WARWICK - ORANGE COUNTY - NEW YORK

ERS ENGINEERING CONSULTANTS, P.C.

PHONE: (845) 987-1775 FAX: (845) 987-1788
11 FORESTER AVE., WARWICK, NEW YORK 10990

SCALE:	DATE:	JOB NO.	SHEET NO.
1"=80'	03-31-20	3121	1 OF 3

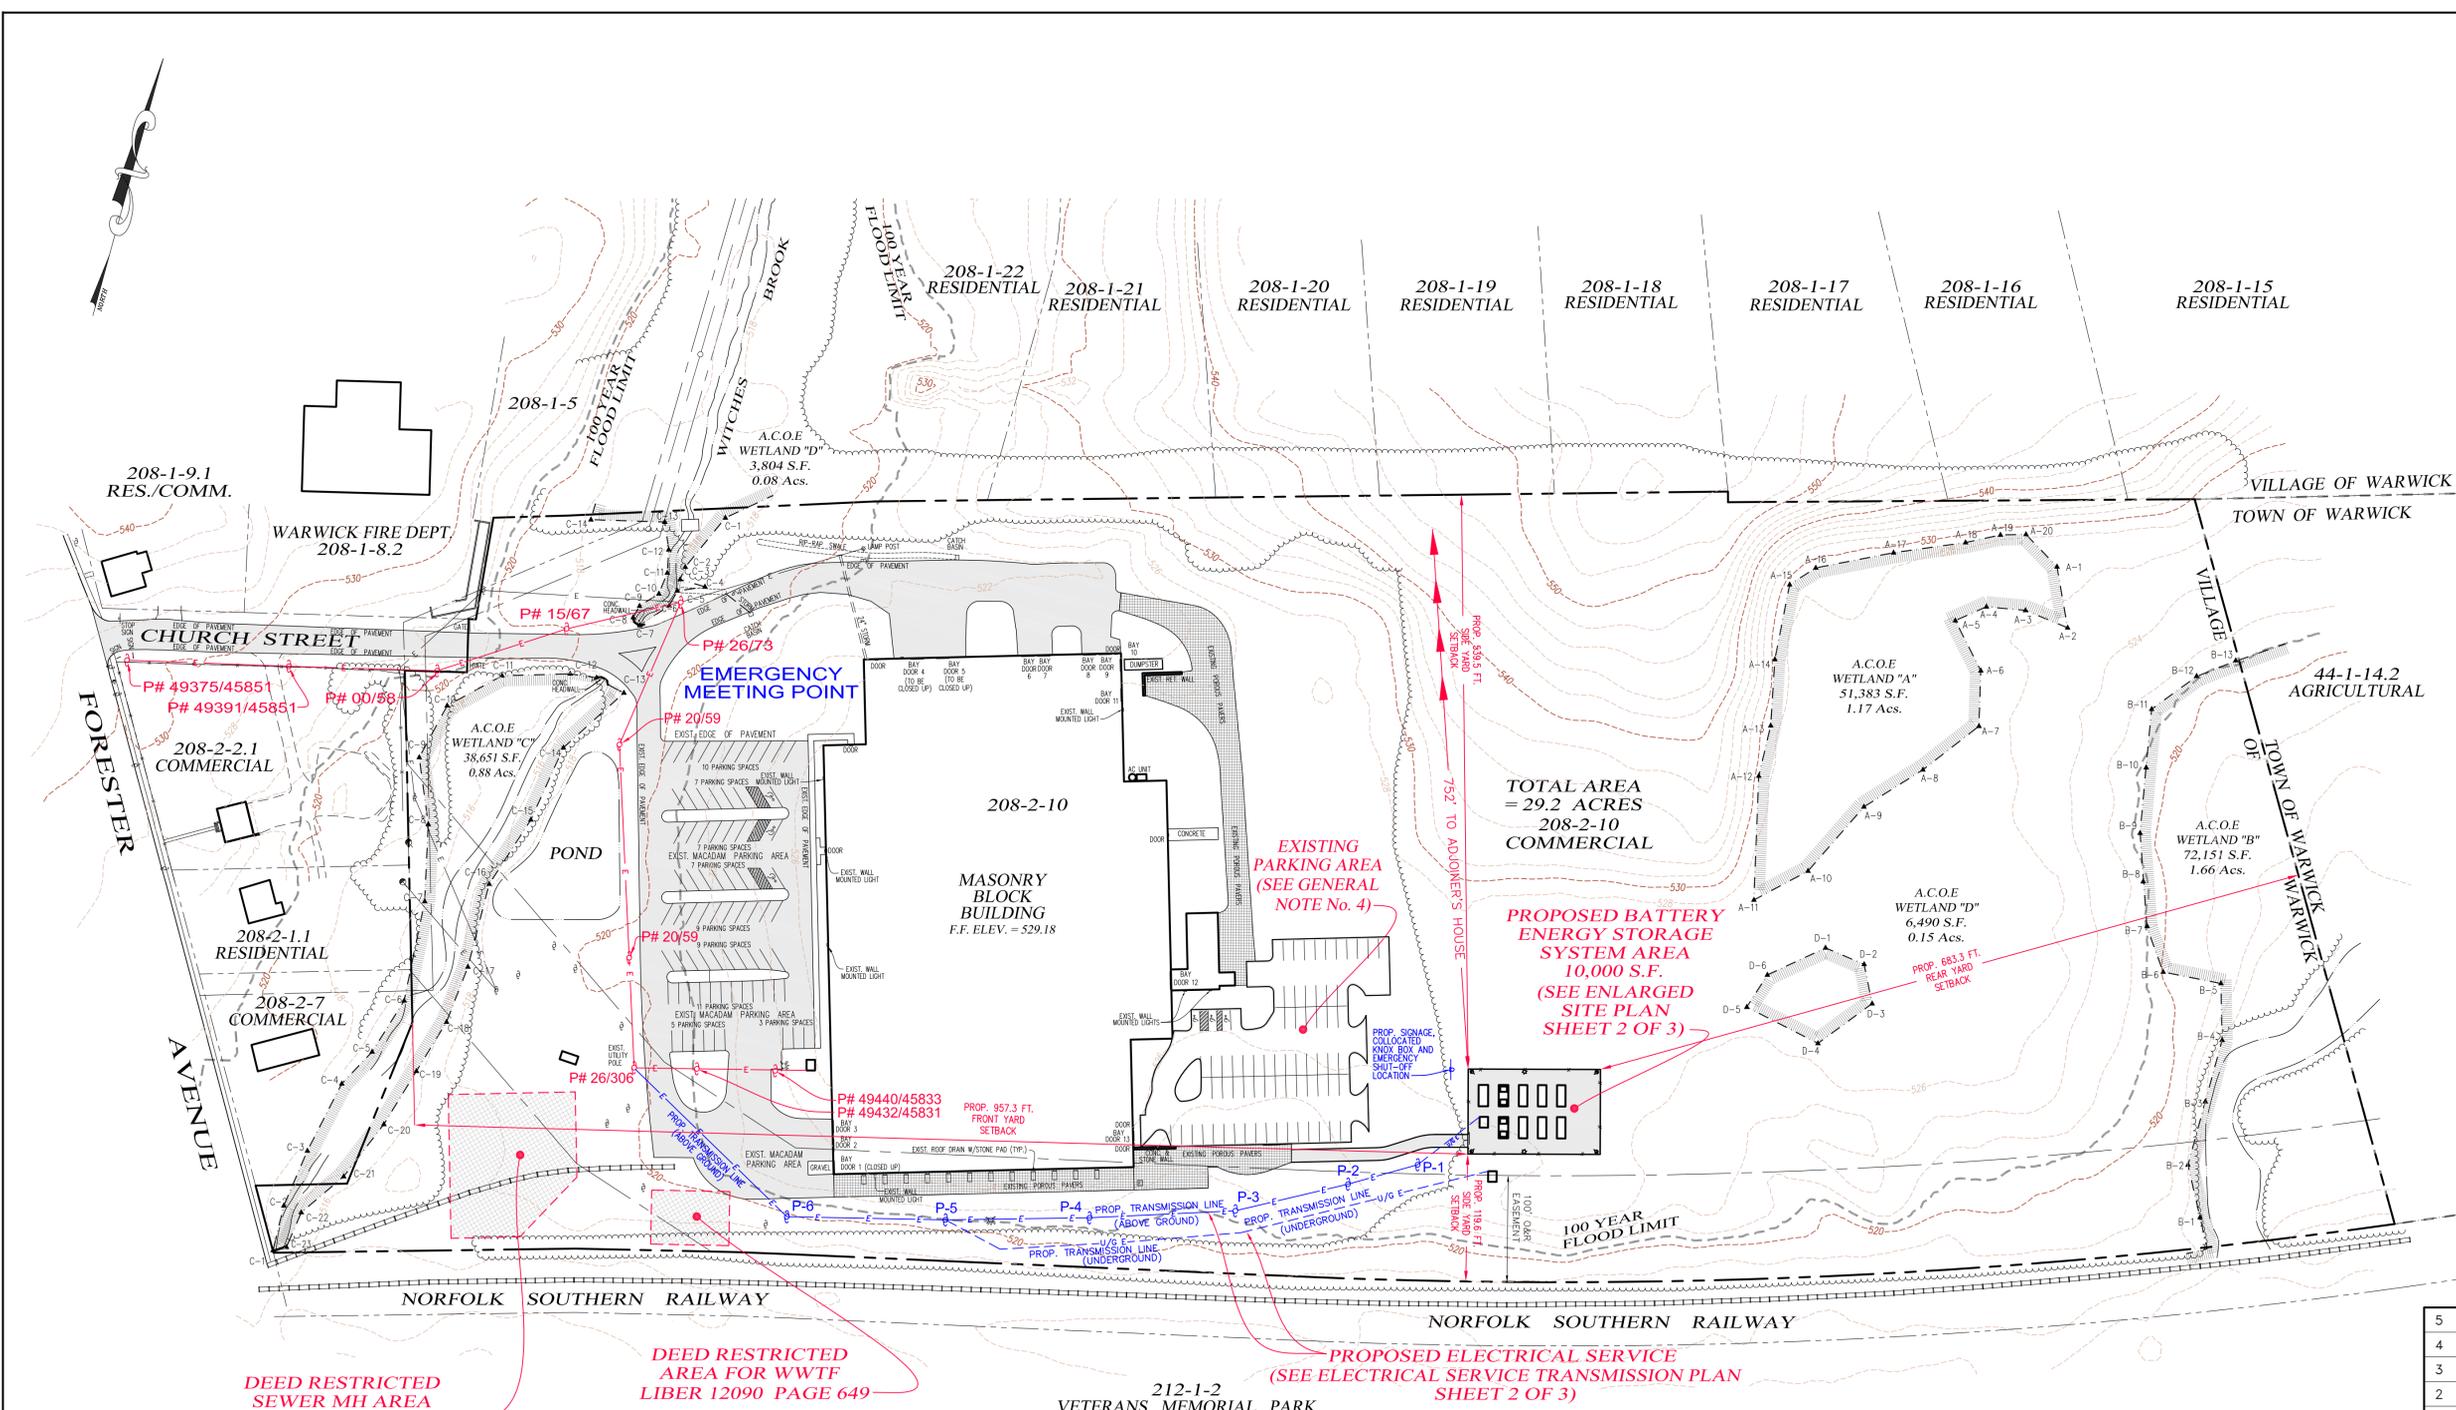


- GENERAL NOTES:**
1. TOPOGRAPHIC DATA PREPARED BY ERS CONSULTANTS, INC.
 2. WETLAND DELINEATION PREPARED ERS CONSULTANTS ON 03-11-20.
 3. FLOOD MAPPING PER FIRM PANEL No. 36071C046E DATED 08-03-09.
 4. EXISTING PARKING AREA: PERMIT ISSUED ON 03-16-20 FROM THE VILLAGE OF WARWICK BUILDING DEPT.

REFERENCE SITE PLAN:



SITE PLAN ENTITLED "SITE PLAN PREPARED FOR WARWICK VALLEY BBA, LLC & CACTUS PETE BEEF JERKY, LLC" PREPARED BY ERS ENGINEERING CONSULTANTS, P.C. AND DATED: 05-13-16. LAST REVISION DATE: 07-20-16

LEGEND:

- ADJOINER'S PROPERTY LINE
- APPLICANT'S PROPERTY LINE
- EXISTING HYDRANT
- EXISTING UTILITY POLE
- EXISTING INTERMEDIATE CONTOUR
- EXISTING INDEX CONTOUR
- UTILITY EASEMENT
- A.C.O.E. WETLAND LIMIT LINE
- 100 YEAR FLOOD LIMIT LINE
- EXISTING TREELINE

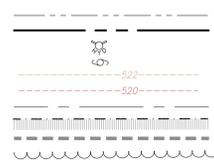

- EXISTING ABOVE GROUND ELECTRIC
- EXISTING UTILITY POLE AND No. FOR CONNECTION
- EXISTING ABOVE GROUND ELECTRIC FOR CONNECTION
- PROPOSED UTILITY POLE AND No.
- PROPOSED ABOVE GROUND ELECTRIC
- PROPOSED UNDERGROUND ELECTRIC
- PROPOSED TREE CLEARING LIMIT
- PROPOSED SILT FENCE
- PROPOSED LIMIT OF DISTURBANCE

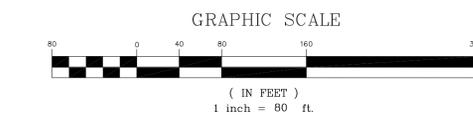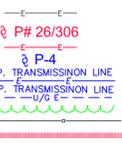

APPROVED AS A FINAL SITE PLAN AS RESOLVED BY THE PLANNING BOARD OF THE VILLAGE OF WARWICK ON DECEMBER 8, 2020

PLANNING BOARD CHAIRMAN _____

PLANNING BOARD ENGINEER _____

OWNER _____

APPLICANT _____

JOHN D. FULLER, P.E.



PROFESSIONAL ENGINEER
N.J. LIC. NO. 42708
N.Y. LIC. NO. 077703

DEED RESTRICTED SEWER MH AREA
LIBER 12090 PAGE 649

DEED RESTRICTED AREA FOR WWTF
LIBER 12090 PAGE 649

PROPOSED ELECTRICAL SERVICE
(SEE ELECTRICAL SERVICE TRANSMISSION PLAN SHEET 2 OF 3)

PROPOSED BATTERY ENERGY STORAGE SYSTEM AREA
10,000 S.F.
(SEE ENLARGED SITE PLAN SHEET 2 OF 3)

EXISTING PARKING AREA
(SEE GENERAL NOTE No. 4)

TOTAL AREA = 29.2 ACRES
208-2-10 COMMERCIAL

MASONRY BLOCK BUILDING
F.F. ELEV. = 529.18

A.C.O.E. WETLAND "C"
38,651 S.F.
0.88 Acs.

A.C.O.E. WETLAND "D"
6,490 S.F.
0.15 Acs.

A.C.O.E. WETLAND "B"
72,151 S.F.
1.66 Acs.

A.C.O.E. WETLAND "A"
51,383 S.F.
1.17 Acs.

A.C.O.E. WETLAND "D"
3,804 S.F.
0.08 Acs.

208-1-9.1 RES./COMM.

WARWICK FIRE DEPT.
208-1-8.2

208-2-2.1 COMMERCIAL

208-2-1.1 RESIDENTIAL

208-2-7 COMMERCIAL

208-2-10

MASONRY BLOCK BUILDING
F.F. ELEV. = 529.18

TOTAL AREA = 29.2 ACRES
208-2-10 COMMERCIAL

44-1-14.2 AGRICULTURAL

A.C.O.E. WETLAND "B"
72,151 S.F.
1.66 Acs.

A.C.O.E. WETLAND "A"
51,383 S.F.
1.17 Acs.

212-1-2 VETERANS MEMORIAL PARK

NORFOLK SOUTHERN RAILWAY

NORFOLK SOUTHERN RAILWAY

FORESTER AVENUE

VILLAGE OF WARWICK
TOWN OF WARWICK

208-1-5
100 YEAR FLOOD LIMIT

208-1-22 RESIDENTIAL

208-1-21 RESIDENTIAL

208-1-20 RESIDENTIAL

208-1-19 RESIDENTIAL

208-1-18 RESIDENTIAL

208-1-17 RESIDENTIAL

208-1-16 RESIDENTIAL

208-1-15 RESIDENTIAL

208-1-5
100 YEAR FLOOD LIMIT

A.C.O.E. WETLAND "D"
3,804 S.F.
0.08 Acs.

208-1-22 RESIDENTIAL

208-1-21 RESIDENTIAL

208-1-20 RESIDENTIAL

208-1-19 RESIDENTIAL

208-1-18 RESIDENTIAL

208-1-17 RESIDENTIAL

208-1-16 RESIDENTIAL

208-1-15 RESIDENTIAL

208-1-5
100 YEAR FLOOD LIMIT

A.C.O.E. WETLAND "D"
3,804 S.F.
0.08 Acs.

208-1-22 RESIDENTIAL

208-1-21 RESIDENTIAL

208-1-20 RESIDENTIAL

208-1-19 RESIDENTIAL

208-1-18 RESIDENTIAL

208-1-17 RESIDENTIAL

208-1-16 RESIDENTIAL

208-1-15 RESIDENTIAL

208-1-5
100 YEAR FLOOD LIMIT

A.C.O.E. WETLAND "D"
3,804 S.F.
0.08 Acs.

208-1-22 RESIDENTIAL

208-1-21 RESIDENTIAL

208-1-20 RESIDENTIAL

208-1-19 RESIDENTIAL

208-1-18 RESIDENTIAL

208-1-17 RESIDENTIAL

208-1-16 RESIDENTIAL

208-1-15 RESIDENTIAL

208-1-5
100 YEAR FLOOD LIMIT

A.C.O.E. WETLAND "D"
3,804 S.F.
0.08 Acs.

208-1-22 RESIDENTIAL

208-1-21 RESIDENTIAL

208-1-20 RESIDENTIAL

208-1-19 RESIDENTIAL

208-1-18 RESIDENTIAL

208-1-17 RESIDENTIAL

208-1-16 RESIDENTIAL

208-1-15 RESIDENTIAL

208-1-5
100 YEAR FLOOD LIMIT

A.C.O.E. WETLAND "D"
3,804 S.F.
0.08 Acs.

208-1-22 RESIDENTIAL

208-1-21 RESIDENTIAL

208-1-20 RESIDENTIAL

208-1-19 RESIDENTIAL

208-1-18 RESIDENTIAL

208-1-17 RESIDENTIAL

208-1-16 RESIDENTIAL

208-1-15 RESIDENTIAL

208-1-5
100 YEAR FLOOD LIMIT

A.C.O.E. WETLAND "D"
3,804 S.F.
0.08 Acs.

208-1-22 RESIDENTIAL

208-1-21 RESIDENTIAL

208-1-20 RESIDENTIAL

208-1-19 RESIDENTIAL

208-1-18 RESIDENTIAL

208-1-17 RESIDENTIAL

208-1-16 RESIDENTIAL

208-1-15 RESIDENTIAL

208-1-5
100 YEAR FLOOD LIMIT

A.C.O.E. WETLAND "D"
3,804 S.F.
0.08 Acs.

208-1-22 RESIDENTIAL

208-1-21 RESIDENTIAL

208-1-20 RESIDENTIAL

208-1-19 RESIDENTIAL

208-1-18 RESIDENTIAL

208-1-17 RESIDENTIAL

208-1-16 RESIDENTIAL

208-1-15 RESIDENTIAL

208-1-5
100 YEAR FLOOD LIMIT

A.C.O.E. WETLAND "D"
3,804 S.F.
0.08 Acs.

208-1-22 RESIDENTIAL

208-1-21 RESIDENTIAL

208-1-20 RESIDENTIAL

208-1-19 RESIDENTIAL

208-1-18 RESIDENTIAL

208-1-17 RESIDENTIAL

208-1-16 RESIDENTIAL

208-1-15 RESIDENTIAL

208-1-5
100 YEAR FLOOD LIMIT

A.C.O.E. WETLAND "D"
3,804 S.F.
0.08 Acs.

208-1-22 RESIDENTIAL

208-1-21 RESIDENTIAL

208-1-20 RESIDENTIAL

208-1-19 RESIDENTIAL

208-1-18 RESIDENTIAL

208-1-17 RESIDENTIAL

208-1-16 RESIDENTIAL

208-1-15 RESIDENTIAL

208-1-5
100 YEAR FLOOD LIMIT

A.C.O.E. WETLAND "D"
3,804 S.F.
0.08 Acs.

208-1-22 RESIDENTIAL

208-1-21 RESIDENTIAL

208-1-20 RESIDENTIAL

208-1-19 RESIDENTIAL

208-1-18 RESIDENTIAL

208-1-17 RESIDENTIAL

208-1-16 RESIDENTIAL

208-1-15 RESIDENTIAL

208-1-5
100 YEAR FLOOD LIMIT

A.C.O.E. WETLAND "D"
3,804 S.F.
0.08 Acs.

208-1-22 RESIDENTIAL

208-1-21 RESIDENTIAL

208-1-20 RESIDENTIAL

208-1-19 RESIDENTIAL

208-1-18 RESIDENTIAL

208-1-17 RESIDENTIAL

208-1-16 RESIDENTIAL

208-1-15 RESIDENTIAL

208-1-5
100 YEAR FLOOD LIMIT

A.C.O.E. WETLAND "D"
3,804 S.F.
0.08 Acs.

208-1-22 RESIDENTIAL

208-1-21 RESIDENTIAL

208-1-20 RESIDENTIAL

208-1-19 RESIDENTIAL

208-1-18 RESIDENTIAL

208-1-17 RESIDENTIAL

208-1-16 RESIDENTIAL

208-1-15 RESIDENTIAL

208-1-5
100 YEAR FLOOD LIMIT

A.C.O.E. WETLAND "D"
3,804 S.F.
0.08 Acs.

208-1-22 RESIDENTIAL

208-1-21 RESIDENTIAL

208-1-20 RESIDENTIAL

208-1-19 RESIDENTIAL

208-1-18 RESIDENTIAL

208-1-17 RESIDENTIAL

208-1-16 RESIDENTIAL

208-1-15 RESIDENTIAL

208-1-5
100 YEAR FLOOD LIMIT

A.C.O.E. WETLAND "D"
3,804 S.F.
0.08 Acs.

208-1-22 RESIDENTIAL

208-1-21 RESIDENTIAL


208-1-20 RESIDENTIAL

208-1-19 RESIDENTIAL


208-1-18 RESIDENTIAL

208-1-17 RESIDENTIAL

208-1-16 RESIDENTIAL

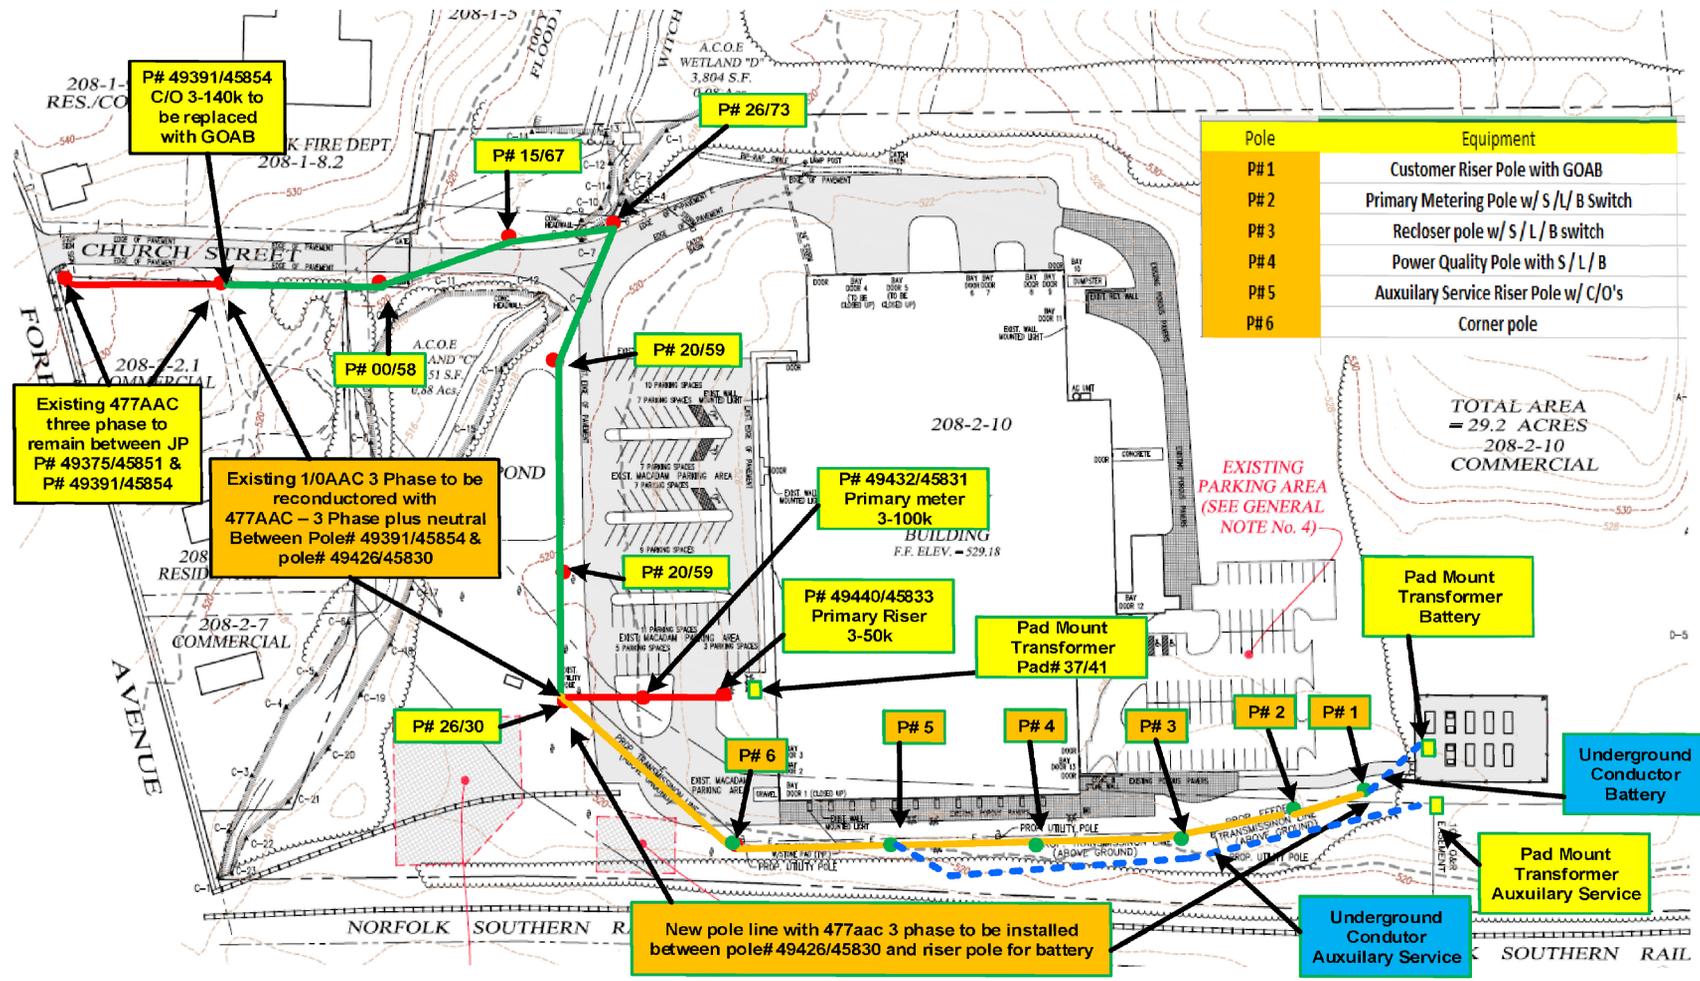

ELECTRICAL SERVICE TRANSMISSION PLAN
(SOURCE: ORANGE & ROCKLAND UTILITIES)
SCALE: 1"=80'

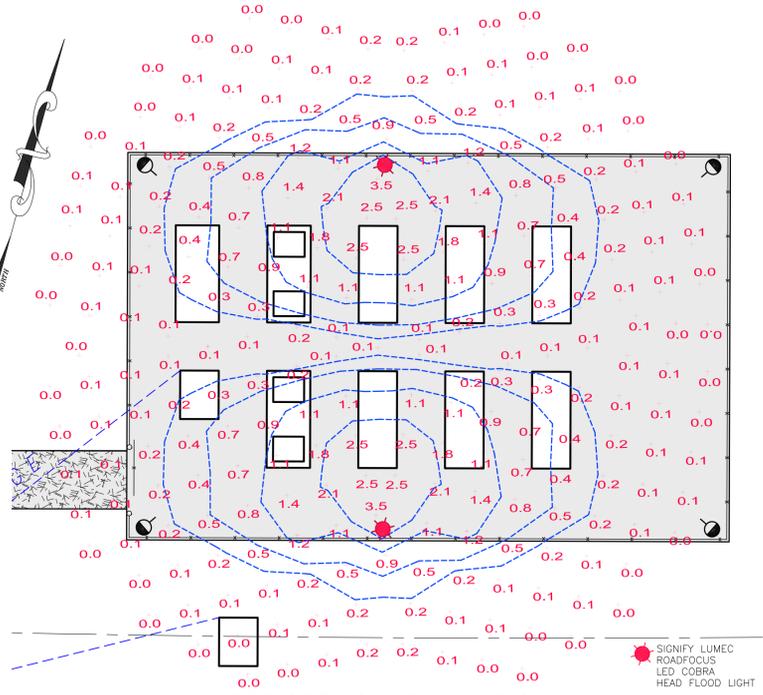


PROPOSED LIGHTING PLAN
SCALE: 1"=20'

(SEE ENLARGED SITE & SEDIMENT & EROSION CONTROL PLAN FOR DETAILS)

LEGEND:

- ADJOINER'S PROPERTY LINE
- APPLICANT'S PROPERTY LINE
- EXISTING HYDRANT
- EXISTING UTILITY POLE
- EXISTING INTERMEDIATE CONTOUR
- EXISTING INDEX CONTOUR
- UTILITY EASEMENT
- A.C.O.E. WETLAND LIMIT LINE
- 100 YEAR FLOOD LIMIT LINE
- EXISTING TREELINE
- EXISTING ABOVE GROUND ELECTRIC
- EXISTING UTILITY POLE AND No. FOR CONNECTION
- EXISTING ABOVE GROUND ELECTRIC FOR CONNECTION
- PROPOSED UTILITY POLE AND No.
- PROPOSED ABOVE GROUND ELECTRIC
- PROPOSED UNDERGROUND ELECTRIC
- PROPOSED TREE CLEARING LIMIT
- PROPOSED SILT FENCE
- PROPOSED LIMIT OF DISTURBANCE

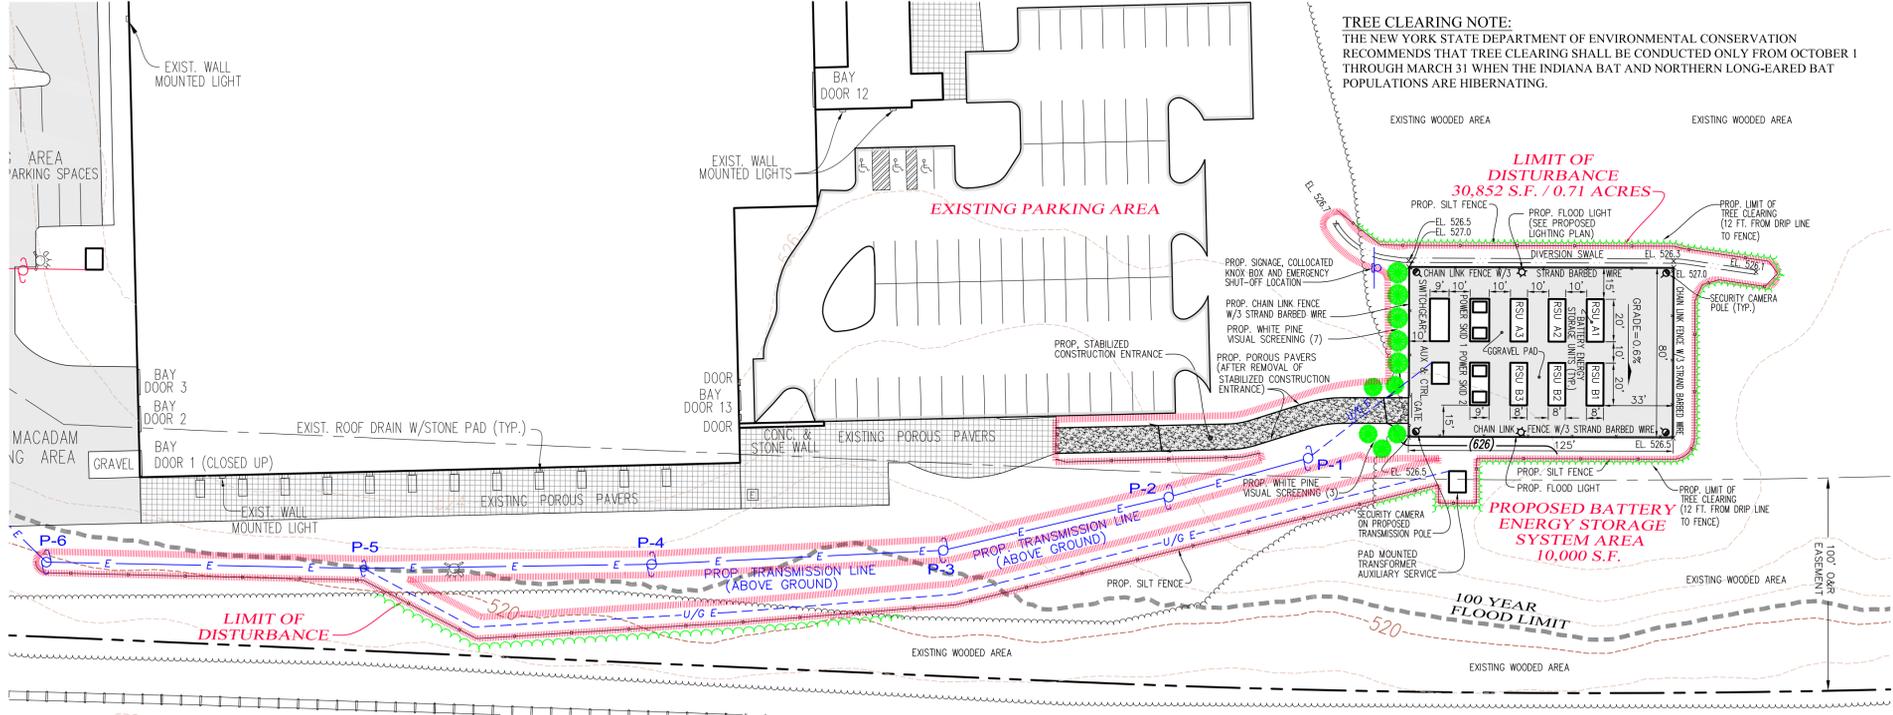

ENLARGED SITE & SEDIMENT & EROSION CONTROL PLAN
SCALE: 1"=40'

TREE CLEARING NOTE:
THE NEW YORK STATE DEPARTMENT OF ENVIRONMENTAL CONSERVATION RECOMMENDS THAT TREE CLEARING SHALL BE CONDUCTED ONLY FROM OCTOBER 1 THROUGH MARCH 31 WHEN THE INDIANA BAT AND NORTHERN LONG-EARED BAT POPULATIONS ARE HIBERNATING.

NO.	DESCRIPTION	DATE
5	REVISED PER PLANNING BOARD COMMENTS DATED 12-08-20	12-09-20
4	REVISED PER PLANNING BOARD COMMENTS DATED 11-03-20	11-11-20
3	O&R SOURCE DATA ADDED TO PLANS	09-10-20
2	REVISED PER PLANNING BOARD COMMENTS DATED 08-04-20	08-06-20
1	REVISED PER PLANNING BOARD COMMENTS DATED 07-06-20	07-16-20

**ELECTRICAL SERVICE TRANSMISSION PLAN
ENLARGED SITE & SEDIMENT & EROSION CONTROL PLAN
PROPOSED LIGHTING PLAN**

PROPOSED BATTERY ENERGY STORAGE SYSTEM AREA
PREPARED FOR



SECTION 208 BLOCK 2 LOT 10
VILLAGE OF WARWICK - ORANGE COUNTY - NEW YORK

ERS ENGINEERING CONSULTANTS, P.C.

PHONE: (845) 987-1775 FAX: (845) 987-1788
11 FORESTER AVE., WARWICK, NEW YORK 10990

JOHN D. FULLER, P.E.




PROFESSIONAL ENGINEER
N.J. LIC. NO. 42708
N.Y. LIC. NO. 077704

SCALE:	DATE:	JOB NO.	SHEET NO.
AS NOTED	03-31-20	3121	2 OF 3


FENCE PROPERTIES	MINIMUM VALUE	STANDARD
GRAB TENSILE STRENGTH (LBS)	90	ASTM 1682
ELONGATION AT FAILURE (%)	50	ASTM D1682
MULEN BURST STRENGTH (PSI)	190	ASTM D3786
PUNCTURE STRENGTH (LBS)	40	ASTM D751 (MODIFIED)
SLURRY FLOW RATE (GAL/MIN/SF)	0.3	
EQUIVALENT OPENING SIZE	40-80	US STD SIEVE CW-02215
ULTRAVIOLET RADIATION STABILITY (%)	90	ASTM G-26

SLOPE STEEPNESS	MAXIMUM FENCE SPACING (FT)
2:1	50
3:1	75
4:1	125
5:1	175
FLATTER THAN 5:1	200

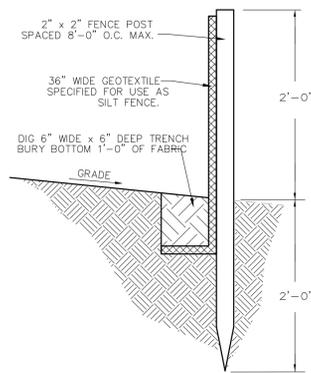


- NOTES:
1. WOVEN WIRE FENCE TO BE FASTENED SECURELY TO FENCE POSTS WITH WIRE TIES OR STAPLES
 2. FILTER CLOTH TO BE FASTENED SECURELY TO WOVEN WIRE FENCE WITH TIES SPACED EVERY 24" AT TOP AND MID SECTION
 3. ALL SILT FENCES SHALL RUN PARALLEL TO THE CONTOUR OF THE LAND.
 4. ALL SILT FENCING SHALL MEET THE MINIMUM REQUIREMENTS AS STATED UNLESS OTHERWISE NOTED AND APPROVED BY THE BUILDING INSPECTOR AND ENGINEER.
 5. MAINTENANCE SHALL BE PERFORMED AS NEEDED AND MATERIAL SHALL BE REMOVED WHEN "BULGES" DEVELOP IN THE SILT FENCE


FILTER FABRIC SILT FENCE DETAIL

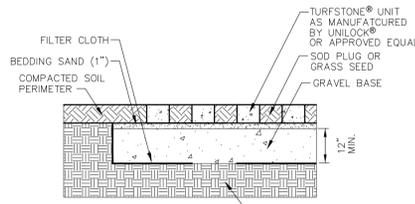


POROUS PAVER DETAIL

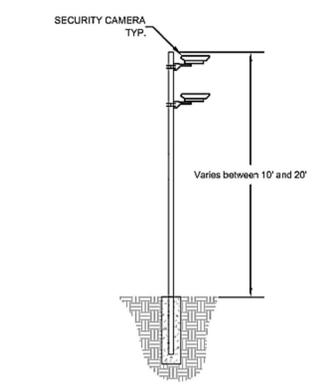


SECURITY CAMERA POLE DETAIL

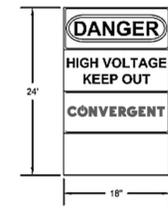


WARNING SIGNAGE

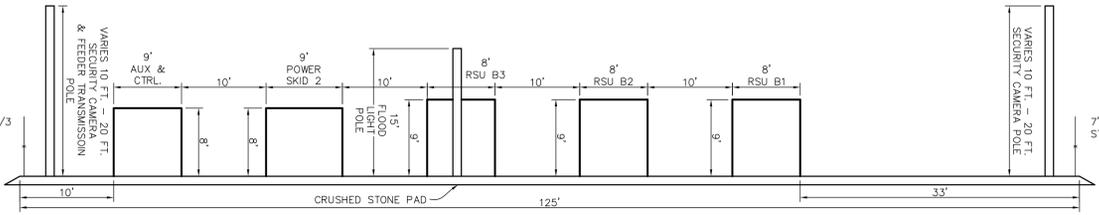

ELEVATION VIEW - PROPOSED BATTERY ENERGY STORAGE SYSTEM AREA

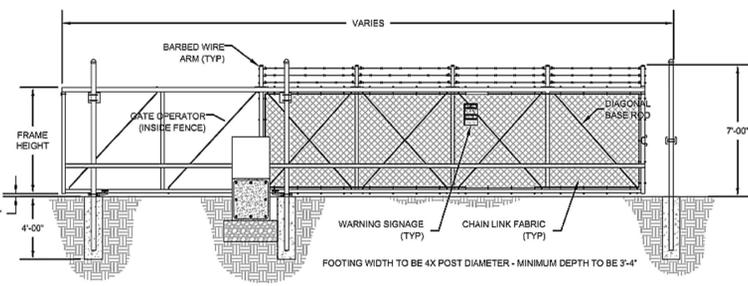


GATE DETAIL

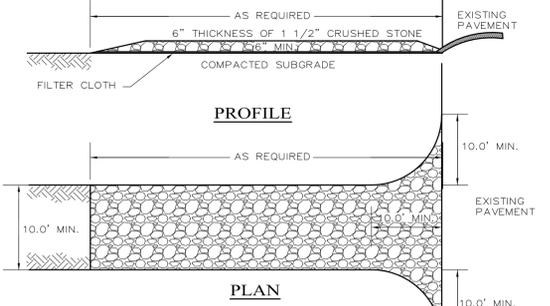


STABILIZED CONSTRUCTION ENTRANCE


- CONSTRUCTION SPECIFICATIONS:
1. ENTRANCE SHALL BE MAINTAINED AS CONDITIONS DEMAND TO PREVENT TRACKING OF SEDIMENT ONTO PUBLIC R.O.W.
 2. A CRUSHED STONE, VEHICLE WHEEL-CLEANING BLANKET WILL BE INSTALLED WHERE A CONSTRUCTION ACCESS ROAD INTERSECTS ANY PAVED ROADWAY. THE BLANKET SHALL BE COMPOSED OF 6" DEPTH OF 1-1/2" CRUSHED STONE.
 3. A FILTER CLOTH WILL BE PLACED OVER THE ENTIRE AREA PRIOR TO PLACING OF STONE.
 4. ALL SURFACE WATER FLOWING OR DIVERTED TOWARD CONSTRUCTION ENTRANCES SHALL BE PIPED ACROSS THE ENTRANCE IF PIPING IS IMPRACTICAL, A MOUNTABLE BERM WITH 5:1 SLOPES WILL BE PERMITTED.
 5. PERIODIC INSPECTION AND NEEDED MAINTENANCE SHALL BE PROVIDED AFTER EACH RAIN.

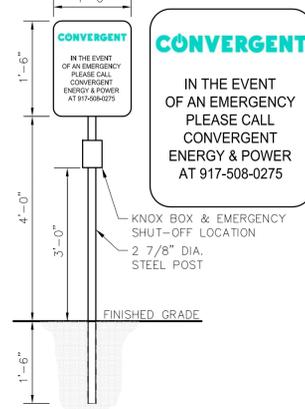


PROPOSED SIGNAGE & COLLOCATED KNOX BOX DETAIL

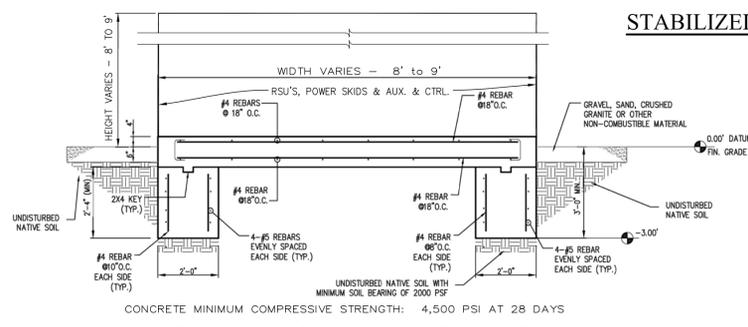


FOUNDATION WIDTH SECTION

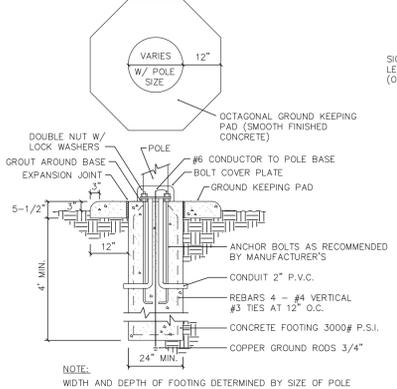


FLOOD LIGHT FOOTING DETAIL

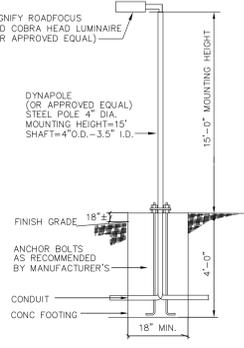

FLOOD LIGHT DETAIL

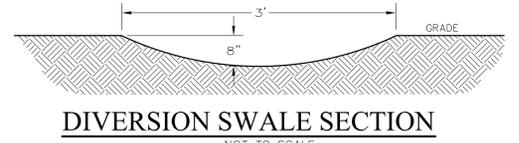


DIVERSION SWALE SECTION

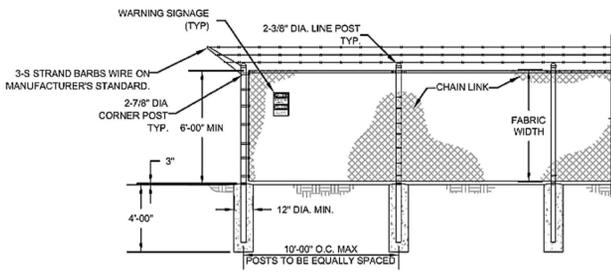


1. CHAIN LINK SHALL BE 2" MESH NO.9 GAGE WIRE SECURITY FASTED TO LINE POSTS AND RAILS.WIRE FASTENERS AND THE CLIPS SHALL BE NO.11 GAGE
2. WIRE CONCRETE FOOTINGS SHALL HAVE TOPS CROWNED AT GROUND LEVEL.
3. CHAIN LINK FENCE TO BE FITTED WITH UV-RESISTANT MESH FABRIC. COLOR PER CUSTOMER REQUEST.
4. ELECTRICAL SAFETY SIGNAGE TO BE PLACED ALONG PERIMETER.

CHAIN LINK FENCE DETAIL

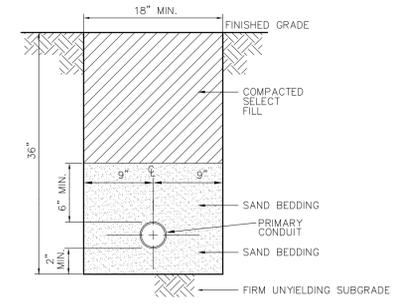

CONDUIT TRENCH DETAIL

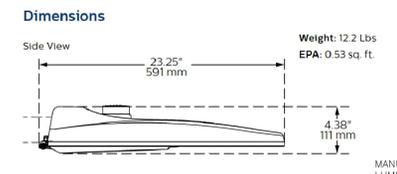

SIGNIFY ROADFOCUS LED COBRA HEAD LUMINAIRE DETAIL

SOIL EROSION AND SEDIMENT CONTROL NOTES:

1. SILT FENCE BARRIERS TO BE INSTALLED PRIOR TO CONSTRUCTION.
2. DISTURBANCE TO BE LIMITED TO NECESSARY GRADING ON ROADS, BUILDING LOCATIONS, DRIVEWAYS AND IN AREAS AS CALLED CALLED FOR IN THE PLANS.
3. TEMPORARY SEEDING WITH ANNUAL RYE GRASS OR OTHER RAPID GROWING MIXTURE TO BE PERFORMED ON DISTURBED SOIL REMAINING VACANT FOR MORE THAN ONE MONTH AS FOLLOWS:
 - A. LOOSEN SEEDS BY DISCING TO 4" DEPTH.
 - B. FERTILIZE WITH 400 LBS. PER ACRE PERENNIAL RYE GRASS.
 - C. SEED WITH 20 LBS. PER ACRE PERENNIAL RYE GRASS.
 - D. MULCH WITH 90 LBS. PER ACRE STRAW, BOUND IN PLACE WITH 200 GALLONS PER ACRE CUTBACK ASPHALT (RC-70).
4. ALL DISTURBED AREAS TO BE MULCHED TO PREVENT EROSION, THE CONTRACTOR SHALL COMPLY WITH ALL REQUESTS OF THE VILLAGE ENGINEER OR BUILDING INSPECTOR DURING CONSTRUCTION WITH REGARD TO EROSION CONTROL DEVICES.
5. EROSION CONTROL MEASURES TO REMAIN IN PLACE AND BE MAINTAINED BY CONTRACTOR UNTIL PERMANENT STABILIZATION HAS BEEN ESTABLISHED.

CONSTRUCTION SEQUENCE

1. ERECT SNOW FENCING AROUND TREES, STRUCTURES, AND OTHER FEATURES TO BE PROTECTED.
2. CONSTRUCT SILT FENCE BARRIERS DOWNSLOPE OF ALL AREAS TO BE DISTURBED.
3. CLEAR AND GRUB VEGETATION IN AREAS TO BE REGRADED.*
4. PERFORM GRADING, EXCAVATION, CONSTRUCTION OF PARKING AREAS, BUILDINGS, UTILITIES, PAVING, ETC..
5. MAINTAIN SILT FENCE BARRIERS AND OTHER MEASURES IN PROPER CONDITION THROUGHOUT THE CONSTRUCTION PERIOD.
6. AS CONSTRUCTION PROCEEDS, ALL DISTURBED AREAS SHALL BE PLANTED, SEEDS, OR PAVED IN A TIMELY MANNER TO PREVENT UNNECESSARY EROSION. ONCE DISTURBED AREAS HAVE BEEN PROPERLY STABILIZED, SILT FENCE, TEMPORARY BERMS, TEMPORARY SWALES, ETC. SHALL BE REMOVED.
7. ADDITIONAL SILT FENCE BARRIERS OR OTHER EROSION AND SEDIMENT CONTROL MEASURES SHALL BE PROVIDED AS DEEMED NECESSARY BY THE VILLAGE ENGINEER OR BUILDING INSPECTOR.

*THE NEW YORK STATE DEPARTMENT OF ENVIRONMENTAL CONSERVATION RECOMMENDS THAT TREE CLEARING SHALL BE CONDUCTED ONLY FROM OCTOBER 1 THROUGH MARCH 31 WHEN THE INDIANA BAT AND NORTHERN LONG-EARED BAT POPULATIONS ARE HIBERNATING.

NO.	DESCRIPTION	DATE
5	REVISED PER PLANNING BOARD COMMENTS DATED 12-08-20	12-09-20
4	REVISED PER PLANNING BOARD COMMENTS DATED 11-03-20	11-11-20
3	O&R SOURCE DATA ADDED TO PLANS	09-10-20
2	REVISED PER PLANNING BOARD COMMENTS DATED 08-04-20	08-06-20
1	REVISED PER PLANNING BOARD COMMENTS DATED 07-06-20	07-16-20

SITE DETAILS

PROPOSED BATTERY ENERGY STORAGE SYSTEM AREA

PREPARED FOR

CONVERGENT

SECTION 208 BLOCK 2 LOT 10
VILLAGE OF WARWICK - ORANGE COUNTY - NEW YORK

JOHN D. FULLER, P.E.

PROFESSIONAL ENGINEER
N.J. LIC. NO. 42708
N.Y. LIC. NO. 077703

ERS ENGINEERING CONSULTANTS, P.C.

PHONE: (845) 987-1775 FAX: (845) 987-1788
11 FORESTER AVE., WARWICK, NEW YORK 10990

SCALE:	DATE:	JOB NO.	SHEET NO.
AS NOTED	03-31-20	3121	3 OF 3